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### SITE DATA

### PROPERTY DESCRIPTION

LANE COUNTY TAX MAP 20-03-28-34 TAX LOT 11600

### PROJECT LOCATION

101 SOUTH 10TH ST. COTTAGE GROVE, OREGON SITE AREA = 14.6 ACRES

### SITE INFORMATION

LIMITS OF DISTURBANCE <1.0 ACRE

### OWNER/APPLICANT

CITY OF COTTAGE GROVE 400 E. MAIN STREET COTTAGE GROVE, OREGON 97424 PHONE: (541) 942-3349 EMAIL: PWDIRECTOR@COTTAGEGROVE.ORG

## UTILITY REPRESENTATIVES

### ELECTRICAL

PACIFIC POWER COTTAGE GROVE DISTRICT CONTACT: ELKE VATH P.O. BOX 248 ALBANY, OR 97322 PHONE: (541) 967-6160 EMAIL: ELKE.VATH@PACIFICORP.COM

EMERALD PEOPLE'S UTILITY DISTRICT (EPUD) CONTACT: JOHN NORRENA 33733 SEAVEY LOOP ROAD EUGENE, OR 97405-9614 PHONE, (541) 735-4366 EMAIL: JOHNN@EPUD.ORG

EC100 EC200 A101 SP1.1 ESC PLAN ESC DETAILS SP1.2 SP2.1 FLOOR PLAN SP2.2 FLOOR PLAN SECTIONS & INTERIOR ELEVATIONS SP2.3 ARCHITECTURAL DETAILS DOOR SCHEDULE & HARDWARE STRUCTURAL NOTES FOUNDATION PLAN STRUCTURAL DETAILS PLANS, ELEVATIONS, & SECTIONS DETAIL SHEET SITE PLAN LAYOUT & MATERIALS PLAN HARDSCAPE DETAILS PLANTING PLAN IRRIGATION PLAN LANDSCAPE & IRRIGATION DETAILS

A201

A301

A501

A601

S001 S101

S501

WT101

WT501

L100 L200 L300 L400

L500

L600

SURVEY DATUMS

HORIZONTAL: OREGON COORDINATE REFERENCE SYSTEM - EUGENE PROJECTION 2011 (EPOCH 2010)

VERTICAL: ELEVATIONS ARE BASED ON RTK GPS OBSERVATIONS USING THE OREGON REAL-TIME GEODETIC NETWORK AND GEOID 12A(NAVD88).

## **DESIGN TEAM**

### **CIVIL ENGINEER**

BRANCH ENGINEERING, INC. CONTACT: DAMIEN GILBERT, P.E. 310 5TH STREET SPRINGFIELD, OR 97477 PHONE: (541) 746-0637 E-MAIL: DAMIENG@BRANCHENGINEERING.COM

### STRUCTURAL ENGINEER

BRANCH ENGINEERING, INC. CONTACT: JOSHUA ANNETT, PROJECT MANAGER 310 5TH STREET SPRINGFIELD, OR 97477 PHONE: (541) 746-0637 E-MAIL: JOSHA@BRANCHENGINEERING.COM

### FIRE

STATEMENT OF SPECIAL INSPECTION

TABLE 1705.3 REQUIRED SPECIAL INSPECTIONS AND TESTS OF CONCRETE CONSTRUCTION

TYPE

SOUTH LANE COUNTY FIRE & RESCUE CONTACT: DANNY L. SOLESBEE 233 HARRISON AVE COTTAGE GROVE, OR 97424 PHONE: (541) 942-4493 EMAIL: DSÒLESBEE@SOUTHLANEFIRE.ORG

### COMMUNICATION SERVICES

CENTURY LINK CONTACT: TREVOR GILBERT 112 E. 10TH AVE. EUGENE, OR 97401 PHONE: (541) 484-7827 EMAIL: TRÈVOR.W.GILBERT@LUMEN.COM

CONT. PERIODIC

### SURVEYOR

SPLASH PAD FEATURE LAYOUT SPLASH PAD PLUMBING LAYOUT

DETAILS & SPECS

DETAILS & SPECS

DETAILS & SPECS

BRANCH ENGINEERING, INC. CONTACT: DAN NELSON, P.L.S. 310 5TH STREET SPRINGFIELD, OR 97477 PHONE: (541) 746-0637 E-MAIL: DANN@BRANCHENGINEERING.COM

### LANDSCAPE ARCHITECT

DOUGHERTY LANDSCAPE ARCHITECTS 474 WILLAMETTE STREET, SUITE 305 EUGENE, OR 97401 PHONE: (541) 683-5803

### CHARTER COMMUNICATIONS

CONTACT: MARK STANFIELD PHONE: (541) 458-0097 EMAIL: MARK.STANFIELD@CHARTER.COM OR CONTACT: SHANE QUIMBY PHONE: (541) 228-7521 EMAIL: SHANÉ.QUIMBY@CHARTER.COM

### WATER, SANITARY, STORM SEWER & CITY FIBER OPTICS

CITY OF COTTAGE GROVE CONTACT: GREG GRISWELL, PUBLIC WORKS SUPERVISOR 400 E MAIN STREET COTTAGE GROVE, OR 97424 PHONE: (541) 942-3024 EMAIL: UTILITIES@COTTAGEGROVE.ORG

## ENERGY CODE COMPLIANCE

				DUILDING LIVELOFE IS SI	HOWN HENLIN AS N		VENIENIS I UN SEN	
1. INSPECT REINFORCEMENT AND VERIFY PLACEMENT.			ACI 318: Ch. 20, 25.2, 25.3,	SPACE USING ASHRAE 90.1–2019 PRESCRIPTIVE BUILDING ENVELOPE COMPLIANCE PATH. BUILDING ENVELOPE REQUIREMENTS				
			26.6.1-26.6.3					
3. INSPECT ANCHORS CAST IN CONCRETE.		Х	ACI 318: 17.8.2	CLIM	ATE ZONE 4C -	- SEMI-HEATED		
<ul><li>4. INSPECT ANCHORS POST-INSTALLED IN HARDENED CONCRETE MEMBERS.</li><li>b. MECHANICAL ANCHORS AND ADHESIVE ANCHORS NOT DEFINED IN 4.a.</li></ul>		Х	ACI 318: 17.8.2	OPAQUE ELEMENT <sup>1</sup>	ASSEMBLY MAX.		MIN. R-VALUE <sup>2</sup>	MIN. R-VALUE <sup>2</sup> (WOOD-FRAMED
5. VERIFY USE OF REQUIRED DESIGN MIX.		Х	ACI 318: Ch. 19, 26.4.3, 26.4.4				(METAL BLDG)	& OTHER)
			ASTM C172	ROOF	U-0	0.082	R-19	R-30
6. PRIOR TO CONCRETE PLACEMENT, FABRICATE SPECIMENS FOR STRENGTH TESTS, PERFORM SLUMP AND AIR CONTENT TESTS, AND DETERMINE THE TEMPERATURE OF THE CONCRETE.	X		ASTM C31 ACI 318: 26.5,	WALLS, ABOVE GRADE	U-(	).162	R-13	R-13
Security and that the fear electronic of the contract.			26.12	SLAB-ON-GRADE FLOOR - UNHEATED	F-C	0.730	NR	NR
8. VERIFY MAINTENANCE OF SPECIFIED CURING TEMPERATURE AND TECHNIQUES.		X ACI 318: 26.5.3–26.5.5		OPAQUE SWINGING DOOR	U-(	).370		
			ACI 318:	OPAQUE NON-SWINGING DOOR	U-0.360			
12. INSPECT FORMWORK FOR SHAPE, LOCATION AND DIMENSIONS OF THE CONCRETE MEMBER BEING FORMED.		Х	26.11.1.2(b)	VERTICAL FENESTRATION 0-40% OF WALL	ASSEMBLY MAX. U	ASSEMBLY MAX. SHGC	ASSEMBLY MIN. VT/SHGC	
TABLE 1705.6				FIXED	0.50	51100		
REQUIRED SPECIAL INSPECTIONS AND TESTS OF	SOILS					NR	NR	
VERIFICATION & INSPECTION	CONT.	CONT. PERIODIC		OPERABLE	0.65	(FOR ALL TYPES)	(FOR ALL TYPES)	
. VERIFY MATERIALS BELOW SHALLOW FOUNDATIONS ARE ADEQUATE TO ACHIEVE THE DESIGN				ENTRANCE DOOR	0.77			
BEARING CAPACITY.			X	SKYLIGHT 0-3% OF ROOF	ASSEMBLY MAX. U	ASSEMBLY MAX.	ASSEMBLY MIN. VT/SHGC	
2. VERIFY EXCAVATIONS ARE EXTENDED TO PROPER DEPTH AND HAVE REACHED PROPER MATERIAL.			Х	ALL TYPES	0.75	NR	NR	
3. PERFORM CLASSIFICATION AND TESTING OF COMPACTED FILL MATERIALS.			Х	1. SEE SHEET A501 FOR ASSEMBLY DETAIL	LS.			•
4. VERIFY USE OF PROPER MATERIALS, DENSITIES AND LIFT THICKNESSES DURING PLACEMENT AND COMPACTION OF COMPACTED FILL.	Х			2. SEMIEXTERIOR BUILDING ENVELOPE PER	ASHRAE 90.1–201	9 5.5.2		
5. PRIOR TO PLACEMENT OF COMPACTED FILL, INSPECT SUBGRADE AND VERIFY THAT SITE HAS BEEN PREPARED PROPERLY.			Х	<b>SEMI—HEATED SPACE NOTES</b> (ASHRAE STANDARD 90.1—2019 3.2 DEFINITIONS — SPACE): 1. HEATING SYSTEM OUTPUT CAPACITY SHALL BE LESS THAN 8 BTU/hr*ft <sup>2</sup> (TABLE 3.2)			,	
		•		2. COOLING SYSTEM C			, ,	,


REFERENCED

STANDARD


# **BOHEMIA PARK EXPANSION CITY OF COTTAGE GROVE**

# 101 SOUTH 10TH STREET COTTAGE GROVE, OREGON

EDA AWARD NUMBER: 07-79-07918; URI:118958

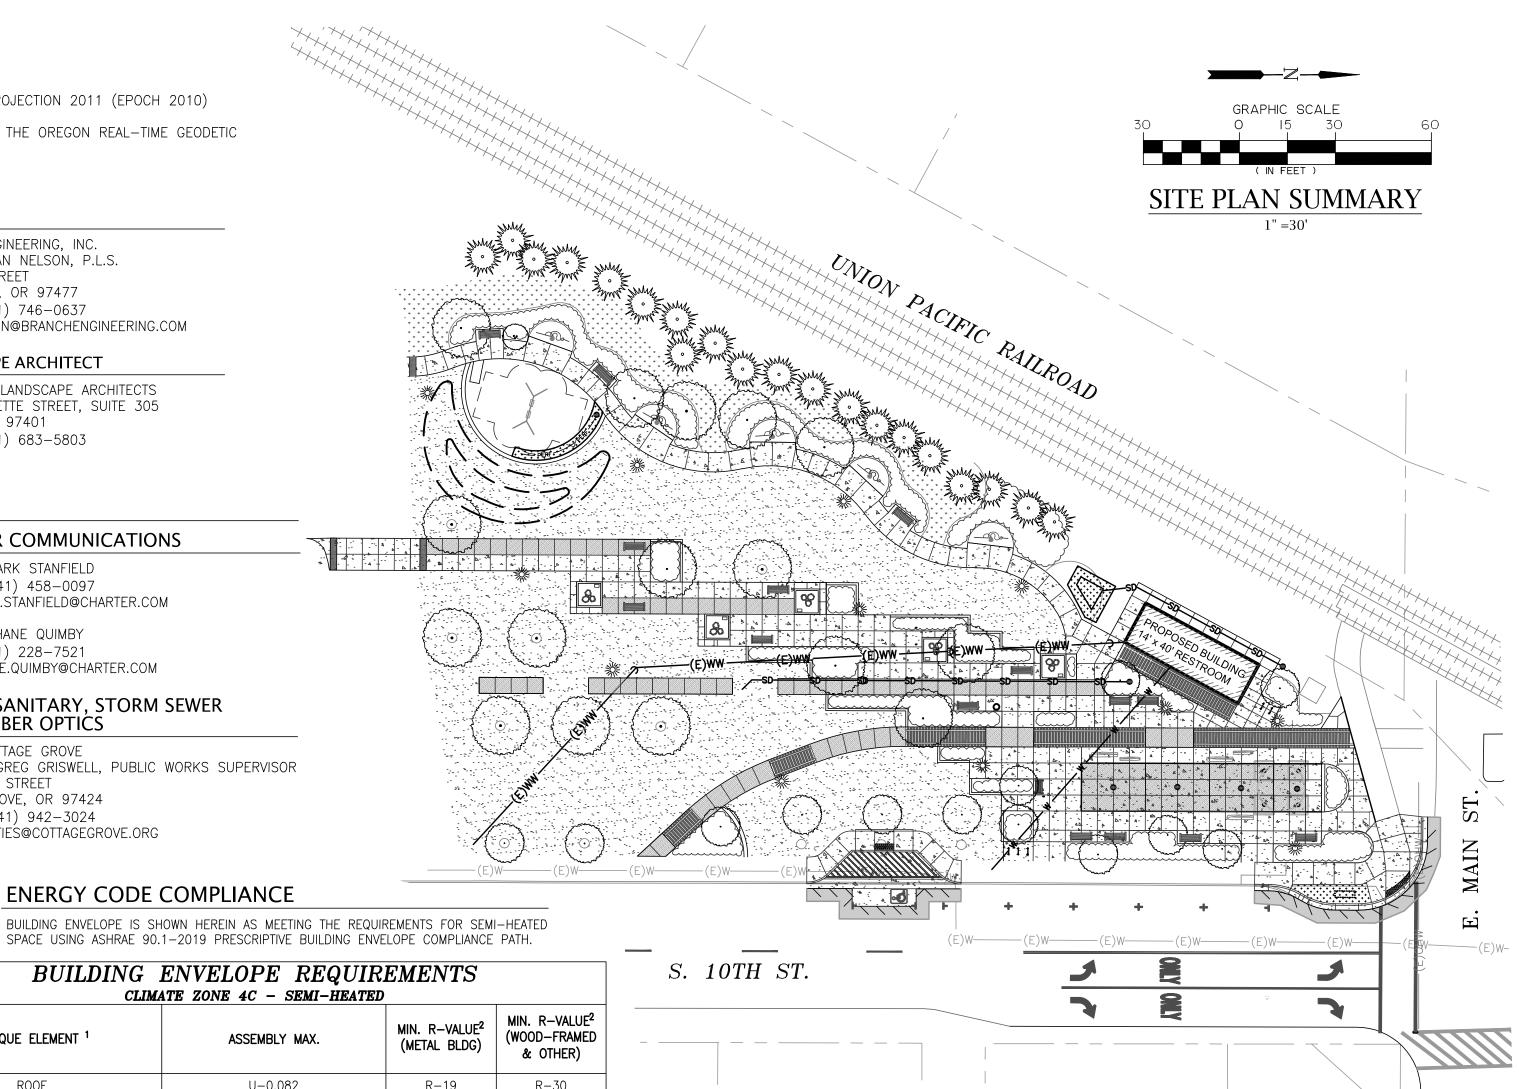



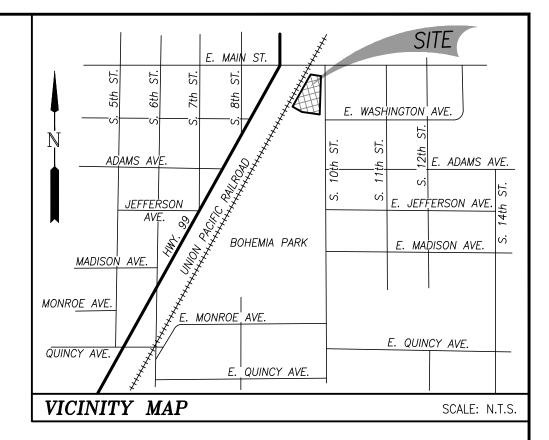

ION	DATE		Y OF COTT EMIA PARK			
			Sheet No. <b>GO</b>			
		DRAWN BY:	CHECKED BY:	DATE:		
		JLB, JJA	RH	04/10/24	JOB No.	22-001K

# GENERAL CONSTRUCTION NOTES

- 1. ALL MATERIALS AND WORKMANSHIP OF ITEMS TO BE MAINTAINED BY THE CITY OF COTTAGE GROVE WITHIN PUBLIC EASEMENTS OR STREET RIGHT-OF-WAYS SHALL MEET CURRENT CITY OF COTTAGE GROVE PUBLIC WORKS SPECIFICATIONS. ALL MATERIALS AND WORKMANSHIP OF IMPROVEMENTS THAT WILL BE PRIVATELY OWNED AND MAINTAINED WILL BE BOUND BY THE CURRENT REQUIREMENTS OF THE STATE OF OREGON AMENDMENTS TO THE UNIFORM PLUMBING CODE CURRENT EDITION, OR CITY OF COTTAGE GROVE BUILDING DIVISION REQUIREMENTS.
- 2. ALL WORK SHALL MEET THE FOLLOWING SPECIFICATIONS "2024 OREGON STANDARD SPECIFICATIONS FOR CONSTRUCTION" AND THE "2024 OREGON STANDARD DRAWINGS" AND THE SPECIALS SET FORTH IN THE PROJECT MANUAL FOR THIS PROJECT.
- 3. CONTRACTOR SHALL PROCURE, AND CONFORM TO ALL CONSTRUCTION PERMITS REQUIRED BY THE CITY OF COTTAGE GROVE.
- 4. ATTENTION: OREGON LAW REQUIRES YOU TO FOLLOW RULES ADOPTED BY THE OREGON UTILITY NOTIFICATION CENTER. THOSE RULES ARE SET FORTH IN OAR 952-001-0010 THROUGH OAR 952-001-0090. YOU MAY OBTAIN COPIES OF THE RULES BY CALLING THE CENTER. (NOTE: THE TELEPHONE NUMBER FOR THE OREGON UTILITY NOTIFICATION CENTER IS 800-332-2334 or 811).
- 5. CONTRACTOR TO NOTIFY CITY AND ALL UTILITY COMPANIES A MINIMUM OF 48 BUSINESS HOURS (2 BUSINESS DAYS) PRIOR TO START OF CONSTRUCTION, AND COMPLY WITH ALL OTHER NOTIFICATION REQUIREMENTS OF AGENCIES WITH JURISDICTION OVER THE WORK.
- 6. CONTRACTOR SHALL PROVIDE ALL BONDS AND INSURANCE REQUIRED BY PUBLIC AND/OR PRIVATE AGENCIES HAVING JURISDICTION. WHERE REQUIRED BY PUBLIC AND/OR PRIVATE AGENCIES HAVING JURISDICTION, THE CONTRACTOR SHALL SUBMIT A SUITABLE MAINTENANCE BOND PRIOR TO FINAL PAYMENT.
- 7. ALL MATERIALS AND WORKMANSHIP FOR FACILITIES IN STREET RIGHT-OF-WAY OR EASEMENTS SHALL CONFORM TO APPROVING AGENCIES' CONSTRUCTION SPECIFICATIONS WHEREIN EACH HAS JURISDICTION, INCLUDING BUT NOT LIMITED TO THE CITY, COUNTY, OREGON HEALTH AUTHORITY (OHA) AND THE OREGON DEPARTMENT OF ENVIRONMENTAL QUALITY (DEQ).
- 8. UNLESS OTHERWISE APPROVED BY THE PUBLIC WORKS DIRECTOR, CONSTRUCTION OF ALL PUBLIC FACILITIES SHALL BE DONE BETWEEN 7:00 A.M. AND 7:00 P.M. MONDAY THROUGH FRIDAY.
- 9. THE CONTRACTOR SHALL PERFORM ALL WORK NECESSARY TO COMPLETE THE PROJECT IN ACCORDANCE WITH THE APPROVED CONSTRUCTION DRAWINGS INCLUDING SUCH INCIDENTALS AS MAY BE NECESSARY TO MEET APPLICABLE AGENCY REQUIREMENTS AND PROVIDE A COMPLETED PROJECT.
- 10. ANY INSPECTION BY THE CITY OR OTHER AGENCIES SHALL NOT, IN ANY WAY, RELIEVE THE CONTRACTOR FROM ANY OBLIGATION TO PERFORM THE WORK IN STRICT COMPLIANCE WITH THE CONTRACT DOCUMENTS, APPLICABLE CODES, AND AGENCY REQUIREMENTS.
- 11. CONTRACTOR SHALL MAINTAIN ONE COMPLETE SET OF APPROVED DRAWINGS ON THE CONSTRUCTION SITE AT ALL TIMES WHEREON HE WILL RECORD ALL APPROVED DEVIATIONS IN CONSTRUCTION FROM THE APPROVED DRAWINGS, AS WELL AS THE STATION LOCATIONS AND DEPTHS OF ALL EXISTING UTILITIES ENCOUNTERED. THESE FIELD RECORD DRAWINGS SHALL BE KEPT UP TO DATE AT ALL TIMES AND SHALL BE AVAILABLE FOR INSPECTION BY THE CITY OR DESIGN ENGINEER'S REPRESENTATIVE UPON REQUEST. FAILURE TO CONFORM TO THIS REQUIREMENT MAY RESULT IN DELAY IN PAYMENT AND/OR FINAL ACCEPTANCE OF THE PROJECT.
- 12. UPON COMPLETION OF CONSTRUCTION OF ALL NEW FACILITIES, CONTRACTOR SHALL SUBMIT A CLEAN SET OF FIELD RECORD DRAWINGS CONTAINING ALL AS-BUILT INFORMATION TO THE ENGINEER. ALL INFORMATION SHOWN ON THE CONTRACTOR'S FIELD RECORD DRAWINGS SHALL BE SUBJECT TO VERIFICATION. IF SIGNIFICANT ERRORS OR DEVIATIONS ARE NOTED, AN AS-BUILT SURVEY PREPARED AND STAMPED BY A REGISTERED PROFESSIONAL LAND SURVEYOR SHALL BE COMPLETED AT THE CONTRACTOR'S FXPENSE.
- 13. CONTRACTOR SHALL PROVIDE EROSION CONTROL MEASURES AS NEEDED DURING CONSTRUCTION WITH A MINIMUM EROSION CONTROL OF INLET PROTECTION. THE CONTRACTOR SHALL CONSULT WITH THE CITY FOR ADDITIONAL EROSION CONTROL MEASURES IN EXTREMELY WET WEATHER CONDITIONS.
- 14. THE CONTRACTOR SHALL RETAIN AND PAY FOR THE SERVICES OF A REGISTERED CIVIL ENGINEER AND/OR LAND SURVEYOR LICENSED IN THE STATE OF OREGON TO ESTABLISH CONSTRUCTION CONTROL AND PERFORM INITIAL CONSTRUCTION SURVEYS TO ESTABLISH THE LINES AND GRADES OF IMPROVEMENTS AS INDICATED ON THE DRAWINGS. STAKING FOR BUILDINGS. STRUCTURES. CURBS. GRAVITY DRAINAGE PIPES/STRUCTURES AND OTHER CRITICAL IMPROVEMENTS SHALL BE COMPLETED USING EQUIPMENT ACCURATE TO 0.04 FEET HORIZONTALLY AND 0.02 FEET VERTICALLY. OR BETTER. USE OF GPS EQUIPMENT FOR CONSTRUCTION STAKING OF THESE IMPROVEMENTS IS PROHIBITED. THE REGISTERED PROFESSIONAL SURVEYOR SHALL PROVIDE THE DESIGN ENGINEER WITH COPIES OF ALL GRADE SHEETS FOR CONSTRUCTION STAKING PERFORMED FOR THE PROJECT.
- 15. CONTRACTOR SHALL ERECT AND MAINTAIN BARRICADES, WARNING SIGNS, TRAFFIC CONES PER CITY OF COTTAGE GROVE REQUIREMENTS IN ACCORDANCE WITH THE MUTCD (INCLUDING OREGON AMENDMENTS). ACCESS TO DRIVEWAYS SHALL BE MAINTAINED AT ALL TIMES. ALL TRAFFIC CONTROL MEASURES SHALL BE APPROVED AND IN PLACE PRIOR TO ANY CONSTRUCTION ACTIVITY. PRIOR TO ANY WORK IN THE EXISTING PUBLIC RIGHT-OF-WAY, CONTRACTOR SHALL SUBMIT FINAL TRAFFIC CONTROL PLAN TO THE CITY FOR REVIEW AND ISSUANCE OF A LANE CLOSURE OR WORK IN RIGHT-OF-WAY PERMIT.
- 16. THE CONTRACTOR SHALL BE RESPONSIBLE TO ENSURE THAT ALL REQUIRED OR NECESSARY INSPECTIONS ARE COMPLETED BY AUTHORIZED INSPECTORS PRIOR TO PROCEEDING WITH SUBSEQUENT WORK WHICH COVERS OR THAT IS DEPENDENT ON THE WORK TO BE INSPECTED. FAILURE TO OBTAIN NECESSARY INSPECTION(S) AND APPROVAL(S) SHALL RESULT IN THE CONTRACTOR BEING FULLY RESPONSIBLE FOR ALL PROBLEMS ARISING FROM UNINSPECTED WORK.
- 17. UNLESS OTHERWISE SPECIFIED, THE ATTACHED "REQUIRED TESTING AND FREQUENCY" TABLE OUTLINES THE MINIMUM TESTING SCHEDULE FOR THE PROJECT. THIS TESTING SCHEDULE IS NOT COMPLETE, AND DOES NOT RELIEVE THE CONTRACTOR OF THE RESPONSIBILITY OF OBTAINING ALL NECESSARY INSPECTIONS OR OBSERVATIONS FOR ALL WORK PERFORMED, REGARDLESS OF WHO IS RESPONSIBLE FOR PAYMENT. COST FOR RETESTING SHALL BE BORNE BY THE CONTRACTOR.
- 18. THE LOCATION AND DESCRIPTIONS OF EXISTING UTILITIES SHOWN ON THE DRAWINGS ARE COMPILED FROM AVAILABLE RECORDS AND/OR FIELD SURVEYS. THE ENGINEER OR UTILITY COMPANIES DO NOT GUARANTEE THE ACCURACY OR THE COMPLETENESS OF SUCH RECORDS. CONTRACTOR SHALL FIELD VERIFY LOCATIONS AND SIZES OF ALL EXISTING UTILITIES PRIOR TO CONSTRUCTION.

UTILITY CROSSINGS MARKED OR SHOWN ON THE DRAWINGS SHALL BE POTHOLED USING HAND TOOLS OR OTHER NON BORING METHODS. PRIOR TO EXCAVATING, CONTRACTOR SHALL BE RESPONSIBLE FOR EXPOSING POTENTIAL UTILITY CONFLICTS FAR ENOUGH AHEAD OF CONSTRUCTION TO MAKE NECESSARY GRADE OR ALIGNMENT MODIFICATIONS WITHOUT DELAYING THE WORK.

20. CONTRACTOR SHALL FIELD VERIFY LOCATION AND DEPTH OF ALL EXISTING UTILITIES WHERE NEW FACILITIES CROSS. ALL IF GRADE OR ALIGNMENT MODIFICATION IS NECESSARY, CONTRACTOR SHALL NOTIFY THE DESIGN ENGINEER, AND THE DESIGN ENGINEER OR THE OWNER'S REPRESENTATIVE SHALL OBTAIN APPROVAL FROM THE CITY PRIOR TO CONSTRUCTION.

21. ALL FACILITIES SHALL BE MAINTAINED IN-PLACE BY THE CONTRACTOR UNLESS OTHERWISE SHOWN OR DIRECTED. CONTRACTOR SHALL TAKE ALL PRECAUTIONS NECESSARY TO SUPPORT, MAINTAIN, OR OTHERWISE PROTECT EXISTING UTILITIES AND OTHER FACILITIES AT ALL TIMES DURING CONSTRUCTION. CONTRACTOR TO LEAVE EXISTING FACILITIES IN AN EQUAL OR BETTER-THAN-ORIGINAL CONDITION AND TO THE SATISFACTION OF THE CITY AND THE DESIGN ENGINEER.

22. UTILITIES OR INTERFERING PORTIONS OF UTILITIES THAT ARE ABANDONED IN PLACE SHALL BE REMOVED BY THE CONTRACTOR TO THE EXTENT NECESSARY TO ACCOMPLISH THE WORK. THE CONTRACTOR SHALL PLUG THE REMAINING EXPOSED ENDS OF ABANDONED UTILITIES.

24. THE CONTRACTOR SHALL BE RESPONSIBLE FOR MANAGING CONSTRUCTION ACTIVITIES TO ENSURE THAT PUBLIC STREETS AND RIGHT-OF-WAYS ARE KEPT CLEAN OF MUD, AND DUST OR DEBRIS. DUST ABATEMENT SHALL BE MAINTAINED BY ADEQUATE WATERING OF THE SITE BY THE CONTRACTOR.

25. FINISH PAVEMENT GRADES AT TRANSITION TO EXISTING PAVEMENT SHALL MATCH EXISTING PAVEMENT GRADES OR BE FEATHERED PAST JOINTS WITH PAVEMENT AS REQUIRED TO PROVIDE A SMOOTH, FREE DRAINING SURFACE.

26. ALL EXISTING OR CONSTRUCTED MANHOLES, CLEANOUTS, MONUMENT BOXES, GAS VALVES, WATER VALVES AND SIMILAR STRUCTURES SHALL BE ADJUSTED TO MATCH FINISH GRADE OF THE PAVEMENT, SIDEWALK, LANDSCAPED AREA OR MEDIAN STRIP WHEREIN THEY LIE. VERIFY THAT ALL VALVE BOXES AND RISERS ARE CLEAN AND CENTERED OVER THE OPERATING NUT.

27. CONTRACTOR SHALL SEED AND MULCH (UNIFORMLY BY HAND OR HYDROSEED) EXPOSED SLOPES AND DISTURBED AREAS WHICH ARE NOT SCHEDULED TO BE LANDSCAPED, INCLUDING TRENCH RESTORATION AREAS. IF THE CONTRACTOR FAILS TO APPLY SEED AND MULCH IN A TIMELY MANNER DURING PERIODS FAVORABLE FOR GERMINATION, OR IF THE SEEDED AREAS FAIL TO GERMINATE, THE OWNER REPRESENTATIVE MAY (AT HIS DISCRETION) REQUIRE THE CONTRACTOR TO INSTALL SOD TO COVER SUCH DISTURBED AREAS.

AT THE TRENCH BOTTOM, TRUE TO GRADE. THE BOTTOM OF THE TRENCH EXCAVATION SHALL BE SMOOTH, FREE OF LOOSE

29. THE CONTRACTOR SHALL HAVE APPROPRIATE EQUIPMENT ON SITE TO PRODUCE A FIRM, SMOOTH, UNDISTURBED SUBGRADE MATERIALS OR TOOTH GROOVES FOR THE ENTIRE WIDTH OF THE TRENCH PRIOR TO PLACING THE GRANULAR BEDDING MATERIAL.

30. ALL PIPES SHALL BE BEDDED WITH MINIMUM 6-INCHES OF 3/4"-0 CRUSHED ROCK BEDDING AND BACKFILLED WITH COMPACTED 3/4"-0 CRUSHED ROCK IN THE PIPE ZONE (CRUSHED ROCK SHALL EXTEND A MINIMUM OF 12-INCHES OVER THE TOP OF THE PIPE IN ALL CASES). CRUSHED ROCK OR CDF TRENCH BACKFILL SHALL BE USED UNDER ALL IMPROVED AREAS. INCLUDING PAVEMENT. SIDEWALKS. FOUNDATION SLABS. BUILDINGS. ETC. IN ACCORDANCE WITH THE PLANS & SPECIFICATIONS. GRANULAR TRENCH BACKFILL SHALL BE COMPACTED TO 95% IN ROADWAYS AND 92% OF THE MAXIMUM DRY DENSITY PER AASHTO T-180 TEST METHOD (MODIFIED PROCTOR) OUTSIDE OF ROADWAYS.

31. GRANULAR TRENCH BEDDING AND BACKFILL SHALL CONFORM TO THE REQUIREMENTS OF OSSC (ODOT/APWA) 02630.10 (DENSE GRADED BASE AGGREGATE), 3/4"-O. UNLESS OTHERWISE SHOWN ON THE DRAWINGS, COMPACT GRANULAR BACKFILL TO 95% IN ROADWAYS AND 92% OF THE MAXIMUM DRY DENSITY PER AASHTO T-180 TEST METHOD (MODIFIED PROCTOR) OUTSIDE OF ROADWAYS.

32. ALL PIPED UTILITIES ABANDONED IN PLACE SHALL HAVE ALL OPENINGS CLOSED WITH CONCRETE PLUGS WITH A MINIMUM LENGTH EQUAL TO 2 TIMES THE DIAMETER OF THE ABANDONED PIPE.

33. THE END OF ALL UTILITY SERVICE LINES SHALL BE MARKED WITH A 2-X-4 PAINTED WHITE AND WIRED TO PIPE STUB. THE PIPE DEPTH SHALL BE WRITTEN ON THE POST IN 2" BLOCK LETTERS.

34. ALL NON-METALLIC WATER. SANITARY AND STORM SEWER PIPING SHALL HAVE AN ELECTRICALLY CONDUCTIVE INSULATED 12 GAUGE. SOLID STRAND COPPER TRACER WIRE THE FULL LENGTH OF THE INSTALLED PIPE USING BLUE WIRE FOR WATER AND GREEN WIRE FOR STORM AND SANITARY PIPING. TRACER WIRE SHALL BE EXTENDED UP INTO ALL VALVE BOXES, CATCH BASINS. MANHOLES AND LATERAL CLEANOUT BOXES. TRACER WIRE PENETRATIONS INTO MANHOLES SHALL BE WITHIN 18 INCHES OF THE RIM ELEVATION AND ADJACENT TO MANHOLE STEPS. THE TRACER WIRE SHALL BE TIED TO THE TOP MANHOLE STEP OR OTHERWISE SUPPORTED TO ALLOW RETRIEVAL FROM THE OUTSIDE OF THE MANHOLE.

19. THE CONTRACTOR SHALL BE RESPONSIBLE FOR LOCATING AND MARKING ALL EXISTING SURVEY MONUMENTS OF RECORD (INCLUDING BUT NOT LIMITED TO PROPERTY AND STREET MONUMENTS) PRIOR TO CONSTRUCTION. IF ANY SURVEY MONUMENTS ARE REMOVED, DISTURBED OR DESTROYED DURING CONSTRUCTION OF THE PROJECT, THE CONTRACTOR SHALL RETAIN AND PAY FOR THE SERVICES OF A REGISTERED PROFESSIONAL SURVEYOR LICENSED IN THE STATE OF OREGON TO REFERENCE AND REPLACE ALL SUCH MONUMENTS PRIOR TO FINAL PAYMENT. THE MONUMENTS SHALL BE REPLACED WITHIN A MAXIMUM OF 90 DAYS, AND THE COUNTY SURVEYOR SHALL BE NOTIFIED IN WRITING AS REQUIRED BY PER ORS 209.150.

23. CONTRACTOR SHALL REMOVE ALL EXISTING SIGNS, MAILBOXES, FENCES, LANDSCAPING, ETC., AS REQUIRED TO AVOID DAMAGE DURING CONSTRUCTION AND REPLACE THEM TO EXISTING OR BETTER CONDITION.


28. ALL TAPPING OF EXISTING MUNICIPAL SANITARY SEWER, STORM DRAIN MAINS, AND MANHOLES MUST BE DONE BY CONTRACTOR FORCES.

35. NO TRENCHES IN SIDEWALKS, ROADS, OR DRIVEWAYS SHALL BE LEFT IN AN OPEN CONDITION OVERNIGHT. ALL SUCH TRENCHES SHALL BE CLOSED BEFORE THE END OF EACH WORKDAY AND NORMAL TRAFFIC AND PEDESTRIAN FLOWS RESTORED.

36. CITY FORCES TO OPERATE ALL VALVES, INCLUDING FIRE HYDRANTS, ON EXISTING PUBLIC MAINS.

37. ALL SANITARY SEWER MAINS SHALL BE D3034 SDR35 PVC. ALL FITTINGS 4-INCHES THROUGH 24-INCHES IN DIAMETER SHALL BE PER MANUFACTURERS RECOMMENDATIONS IN CONFORMANCE WITH ODOT STANDARD SPECIFICATIONS SECTION 00445.43.

38. THRUST RESTRAINT SHALL BE PROVIDED ON ALL BENDS, TEES AND OTHER DIRECTION CHANGES PER LOCAL JURISDICTION REQUIREMENTS AND AS SPECIFIED OR SHOWN ON THE DRAWINGS. UNLESS OTHERWISE SHOWN OR APPROVED BY THE ENGINEER.

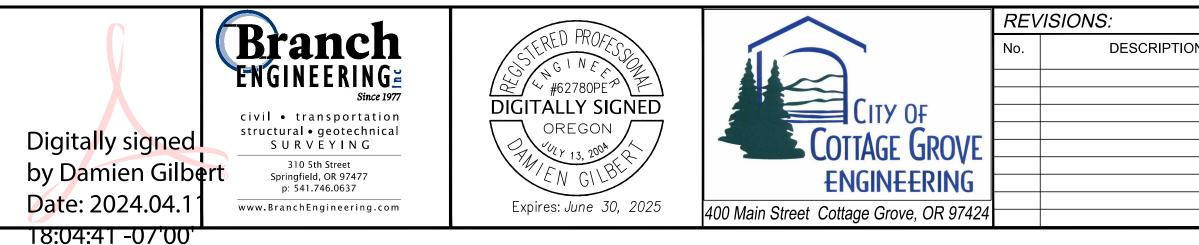

- AGENCY REQUIREMENTS.

- OR STORM LATERALS, ETC.
- DETAIL" ON ODOT STANDARD DRAWING TM800.
- SUBSECTION 00220.02.

REOLIIRED

45. SAWCUT SIDEWALK AT NEWEST CONTROL JOINT IF LOCATED WITHIN 2 FEET OF SAWCUT LINE SHOWN.

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39. CONTRACTOR SHALL REIMBURSE CITY FOR COSTS REQUIRED TO FLUSH, TEST AND DISINFECT WATERLINES PER PUBLIC

40. WHERE THE WATER LINE CROSSES OVER THE SEWER LINE BUT WITH A CLEARANCE OF LESS THAN 18-INCHES VERTICAL SEPARATION, IF THE WATER SUPPLIER DETERMINES THAT THE CONDITIONS ARE NOT FAVORABLE, THE SEWER LINE SHALL BE REPLACED WITH A FULL LENGTH OF PIPE CENTERED AT THE CROSSING POINT, OF PVC PRESSURE PIPE, HIGH DENSITY PE PIPE, DUCTILE-IRON CLASS 50, OR OTHER ACCEPTABLE PIPE; OR THE SEWER SHALL BE ENCASED IN A REINFORCED CONCRETE JACKET FOR A DISTANCE OF 10 FEET ON BOTH SIDES OF THE CROSSING IN ACCORDANCE WITH OAR 333-061-0050 AND LOCAL JURISDICTION REQUIREMENTS.


41. CONTRACTOR TO PROVIDE TESTING OF SANITARY SEWER PIPE AND APPURTENANCES FOR LEAKAGE IN ACCORDANCE WITH TESTING SCHEDULE HEREIN OR THE CITY'S CONSTRUCTION STANDARDS, WHICHEVER ARE MORE STRINGENT. SANITARY SEWER PIPE AND APPURTENANCES SHALL BE TESTED FOR LEAKAGE.

42. CONTRACTOR SHALL NOTIFY AND COORDINATE WITH FRANCHISE UTILITIES FOR REMOVAL OR RELOCATION OF POWER POLES. VAULTS, PEDESTALS, MANHOLES, ETC. TO AVOID CONFLICT WITH CITY UTILITY STRUCTURES, FIRE HYDRANTS, METERS, SEWER

43. ANY ABRUPT EDGE GREATER THAN 2 INCHES IN DEPTH, CLOSER THAN 4 FEET FROM AN ACTIVE TRAFFIC LANE, AND HAVING A DURATION OF EXPOSURE LONGER THAN 72 HOURS SHALL BE REQUIRED TO FOLLOW THE "TYPICAL ABRUPT EDGE SIGNING"

44. WHEN CONSTRUCTION ACTIVITIES BLOCK OR INTERFERE WITH THE NORMAL PEDESTRIAN ROUTING. PROVIDE SAFE PASSAGE FOR PEDESTRIANS THROUGH THE CONSTRUCTION AREA UTILIZING ODOT STANDARD DRAWING TM844 AND THE REQUIREMENTS OF THE CURRENT EDITION OF THE OREGON STANDARD SPECIFICATIONS FOR CONSTRUCTION (BLUE BOOK). REFER TO

TESTING AND FREQUENCY TABLE	F	PARTY RESPONSIBLE FOR PAYMENT				
TESTING AND FREQUENCT TABLE	(	CONTRACTOR				
LOTS, PADS, FILLS, ETC						
EST/6,000 S.F./LIFT (4 MIN.)	Х	SEE NOTE 2				
LL						
1 TEST/200 FOOT TRENCH/LIFT (4 MIN.)	Х	SEE NOTE 2				
RATION 1 TEST/300 FOOT OF TRENCH (4 MIN.)	Х	SEE NOTE 2				
GRAVITY)						
OR HYDROSTATIC PER ODOT REQUIREMENTS. LECTION TESTING PER ODOT REQUIREMENTS. O INSPECTION PER ODOT REQUIREMENTS.	X	SEE NOTE 2				
JM TESTING PER ODOT REQUIREMENTS	Х	SEE NOTE 2				
INDERS FOR ALL STRUCTURES CURBS, SIDEWALKS ITS. UNLESS OTHERWISE SPECIFIED, ONE SET OF O CUBIC YARDS (OR PORTION THEREOF) OF PER DAY. SLUMP & AIR TESTS REQUIRED ON LINDERS.	X	SEE NOTE 2				
EFERS TO CITY'S AUTHORIZED REPRESENTATIVE OF AF CONTRACTOR RESPONSIBLE FOR SCHEDULING TESTIN PRIOR TO PERFORMING SUBSEQUENT WORK. ST BE PERFORMED BY AN APPROVED INDEPENDENT TO IN-PLACE DENSITY TESTING, THE SUBGRADE AND LED WITH A LOADED 10 YARD DUMP TRUCK PROVIDE PROOFROLL SHALL TAKE PLACE IMMEDIATELY PRIOR T O SHALL BE WITNESSED BY THE CITY'S AUTHORIZED F AGENCY. LOCATION AND PATTERN OF PROOFROLL TO RESENTATIVE OR APPROVING AGENCY.	NG. ALL TESTING D BASE F D BY TH O (WITHI REPRESE O BE DIF	TESTING MUST BE LABORATORY OR ROCK SHALL BE IE CONTRACTOR. N 24 HOURS OF) NTATIVE OR RECTED BY SAID				
R SHALL PERFORM PRE-TESTS PRIOR TO SCHEDULING SSURE TESTS, OR PIPELINE MANDREL TEST. FORMED BY CITY OF COTTAGE GROVE. NOTIFY CITY OF (5) BUSINESS DAYS PRIOR TO REQUIRED TESTING.						
DN DATE CITY OF COTT BOHEMIA PARK						
GENERAL NOTES		Sheet No.				
DRAWN BY:     CHECKED BY:       ZZ     DG	DATE: 04/10/	24 JOB No. 22-001				

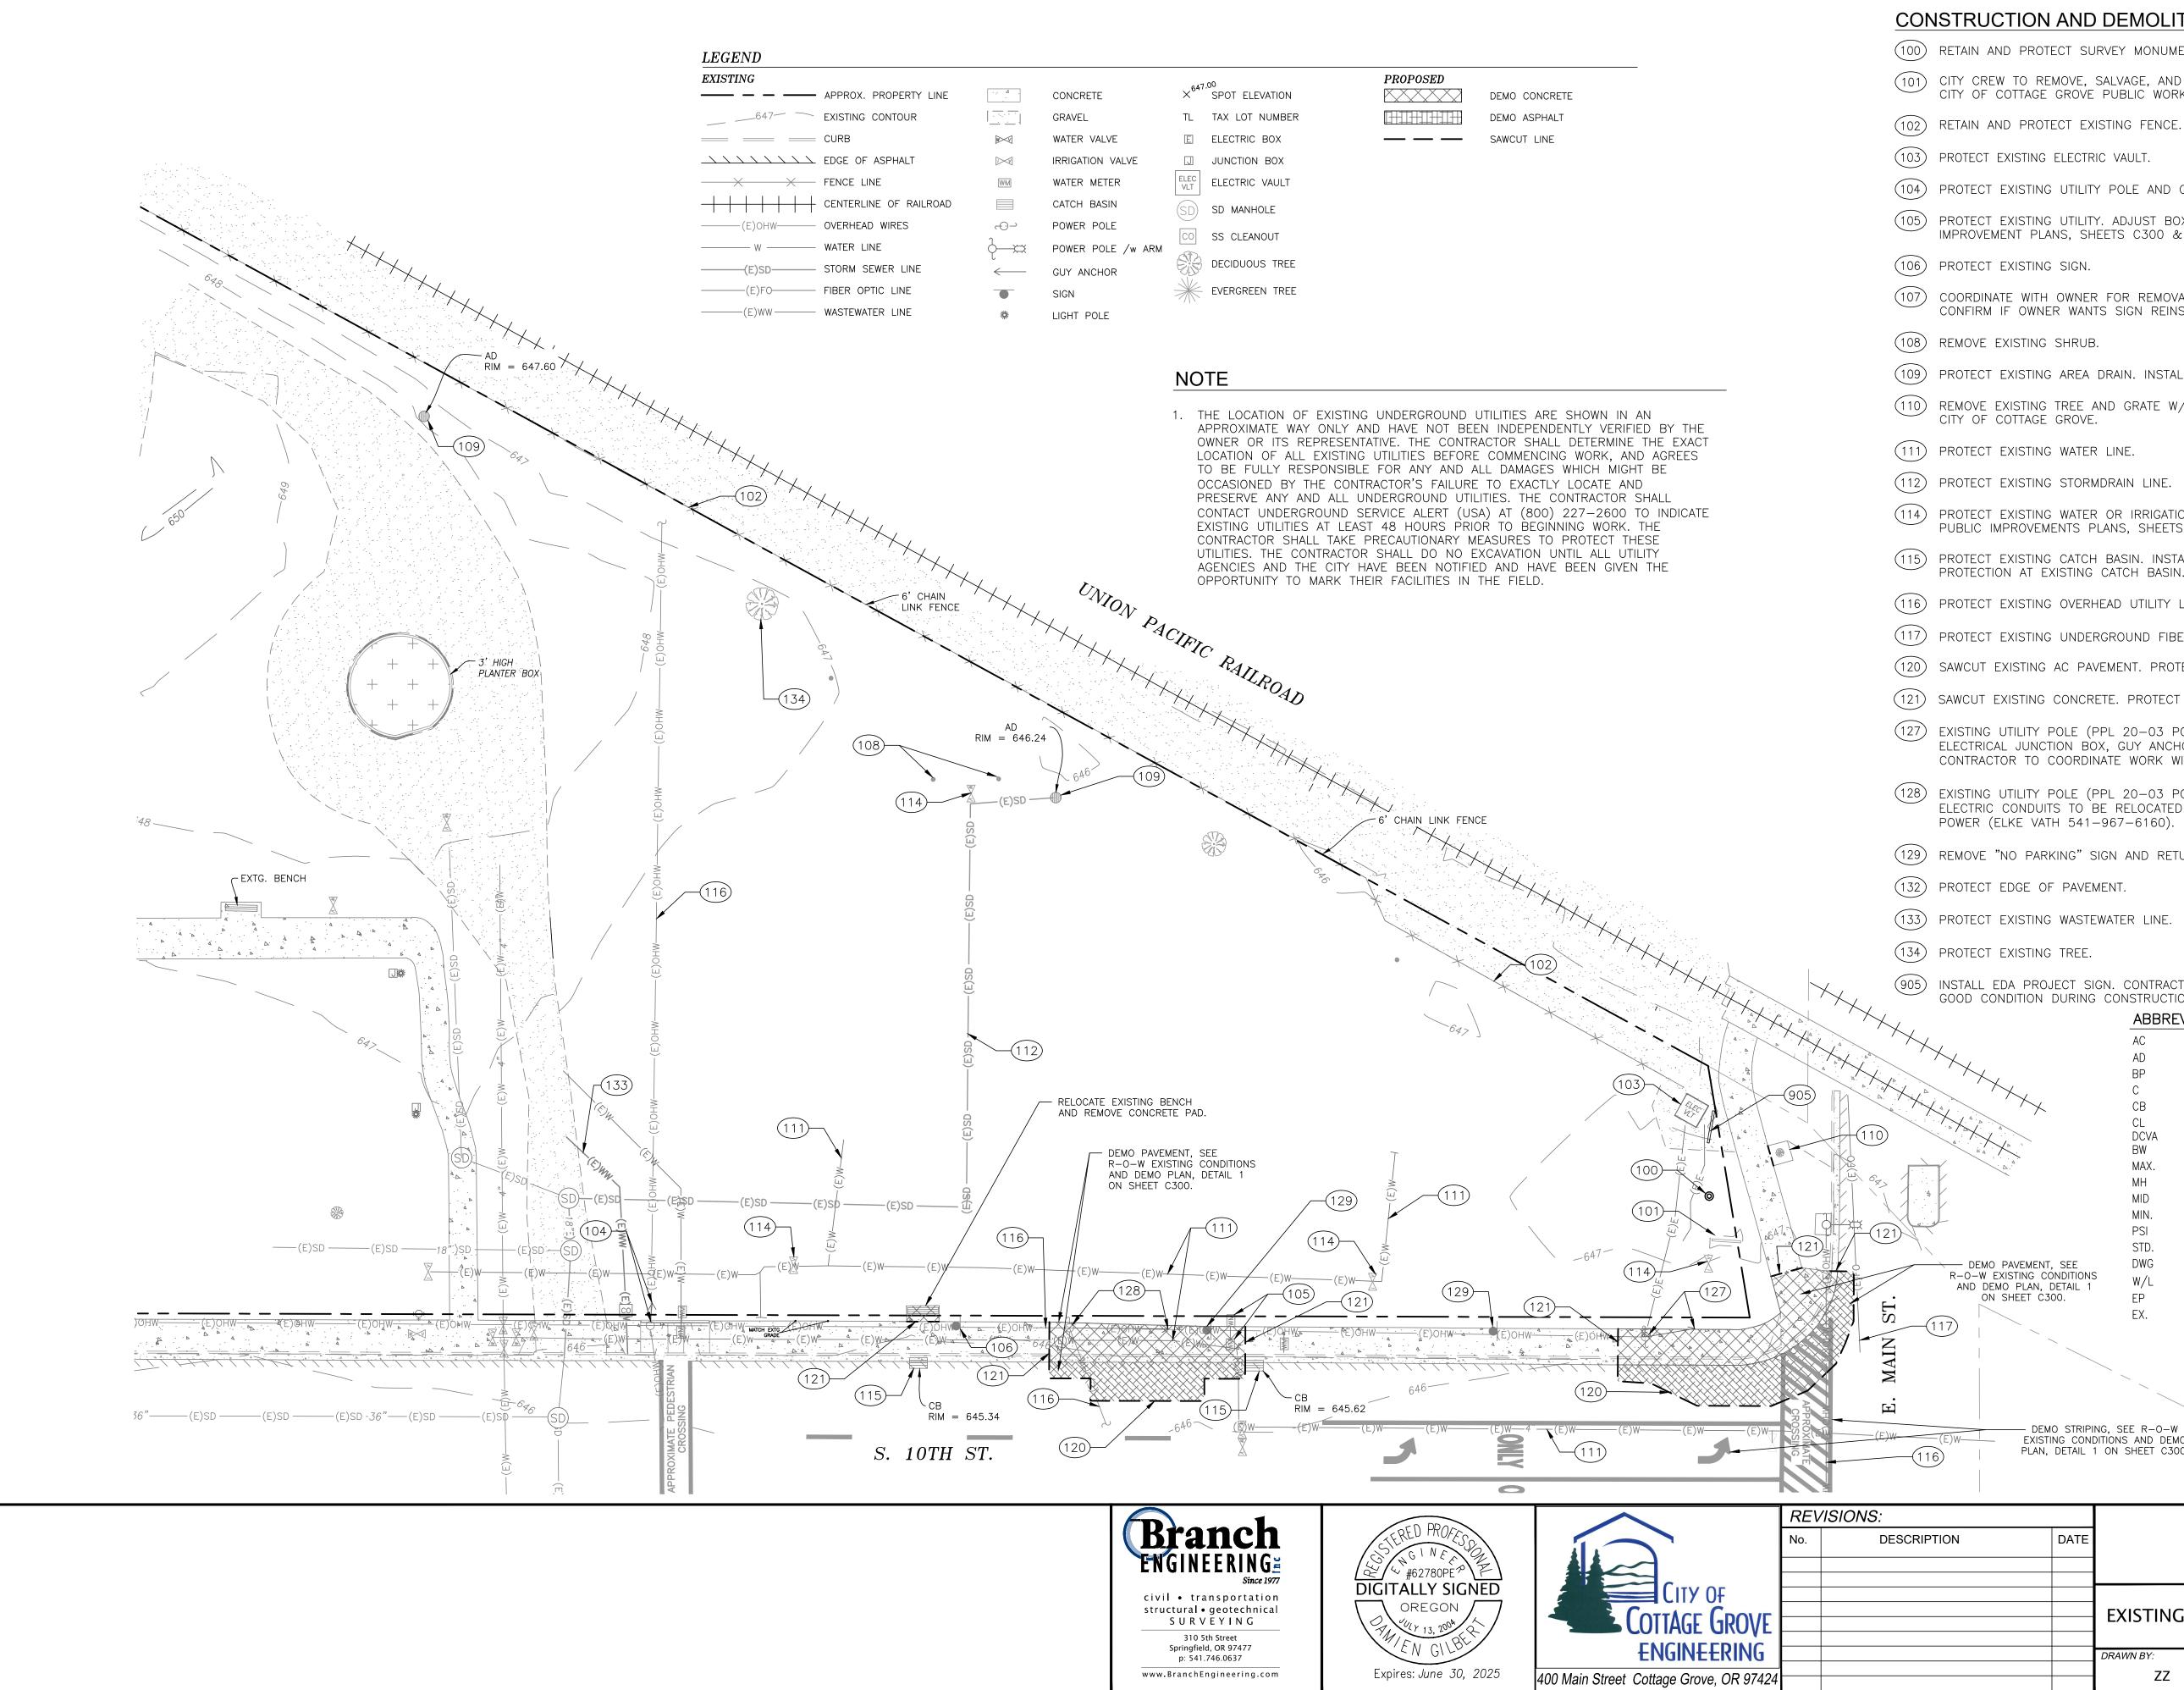

### CONSTRUCTION AND DEMOLITION NOTES:

(100) RETAIN AND PROTECT SURVEY MONUMENT.

(101) CITY CREW TO REMOVE, SALVAGE, AND REINSTALL SIGN TO NEW LOCATION AS DIRECTED BY THE CITY OF COTTAGE GROVE PUBLIC WORKS DIRECTOR.

(103) PROTECT EXISTING ELECTRIC VAULT.

(104) PROTECT EXISTING UTILITY POLE AND GUY ANCHOR.

(105) PROTECT EXISTING UTILITY. ADJUST BOX TO FINISHED GRADE AS NEEDED PER PUBLIC IMPROVEMENT PLANS, SHEETS C300 & C301 AND GRADING & PAVING PLAN SHEET C201.

(106) PROTECT EXISTING SIGN.

(107) COORDINATE WITH OWNER FOR REMOVAL AND RELOCATION OF SIGN AS NECESSARY. CONFIRM IF OWNER WANTS SIGN REINSTALLED.

(108) REMOVE EXISTING SHRUB.

(109) PROTECT EXISTING AREA DRAIN. INSTALL SEDIMENT PROTECTION AT EXISTING AREA DRAIN.

(10) REMOVE EXISTING TREE AND GRATE W/CONCRETE COLLAR. RETURN GRATE TO THE CITY OF COTTAGE GROVE.

(111) PROTECT EXISTING WATER LINE.

(112) PROTECT EXISTING STORMDRAIN LINE.

(114) PROTECT EXISTING WATER OR IRRIGATION VALVE. ADJUST RIM TO FINISHED GRADE AS NEEDED PER PUBLIC IMPROVEMENTS PLANS, SHEETS C300 & C301 AND GRADING & PAVING PLAN SHEET C201.

(115) PROTECT EXISTING CATCH BASIN. INSTALL SEDIMENT PROTECTION AT EXISTING CATCH BASIN.

(116) PROTECT EXISTING OVERHEAD UTILITY LINE.

(117) PROTECT EXISTING UNDERGROUND FIBER OPTIC LINE THAT IS 36" BELOW GRADE PER LUMEN.

(120) SAWCUT EXISTING AC PAVEMENT. PROTECT SAWCUT EDGE FROM DAMAGE.

(121) SAWCUT EXISTING CONCRETE. PROTECT SAWCUT EDGE FROM DAMAGE.

(127) EXISTING UTILITY POLE (PPL 20-03 POLE INVENTORY #284206) TO BE REMOVED AND ELECTRICAL JUNCTION BOX, GUY ANCHOR, AND ELECTRIC CONDUITS TO BE RELOCATED. CONTRACTOR TO COORDINATE WORK WITH PACIFIC POWER (ELKE VATH 541-967-6160).

(128) EXISTING UTILITY POLE (PPL 20-03 POLE INVENTORY #284109), GUY ANCHOR, AND ELECTRIC CONDUITS TO BE RELOCATED. CONTRACTOR TO COORDINATE WORK WITH PACIFIC POWER (ELKE VATH 541-967-6160).

(129) REMOVE "NO PARKING" SIGN AND RETURN TO THE CITY OF COTTAGE GROVE.

ΖZ

(132) PROTECT EDGE OF PAVEMENT.

(133) PROTECT EXISTING WASTEWATER LINE.


(134) PROTECT EXISTING TREE.


### (905) INSTALL EDA PROJECT SIGN. CONTRACTOR SHALL SUPPLY, ERECT, AND MAINTAIN SIGN IN GOOD CONDITION DURING CONSTRUCTION ACCORDING TO EDA SITE SIGN SPECIFICATIONS.

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04/10/24 JOB No.


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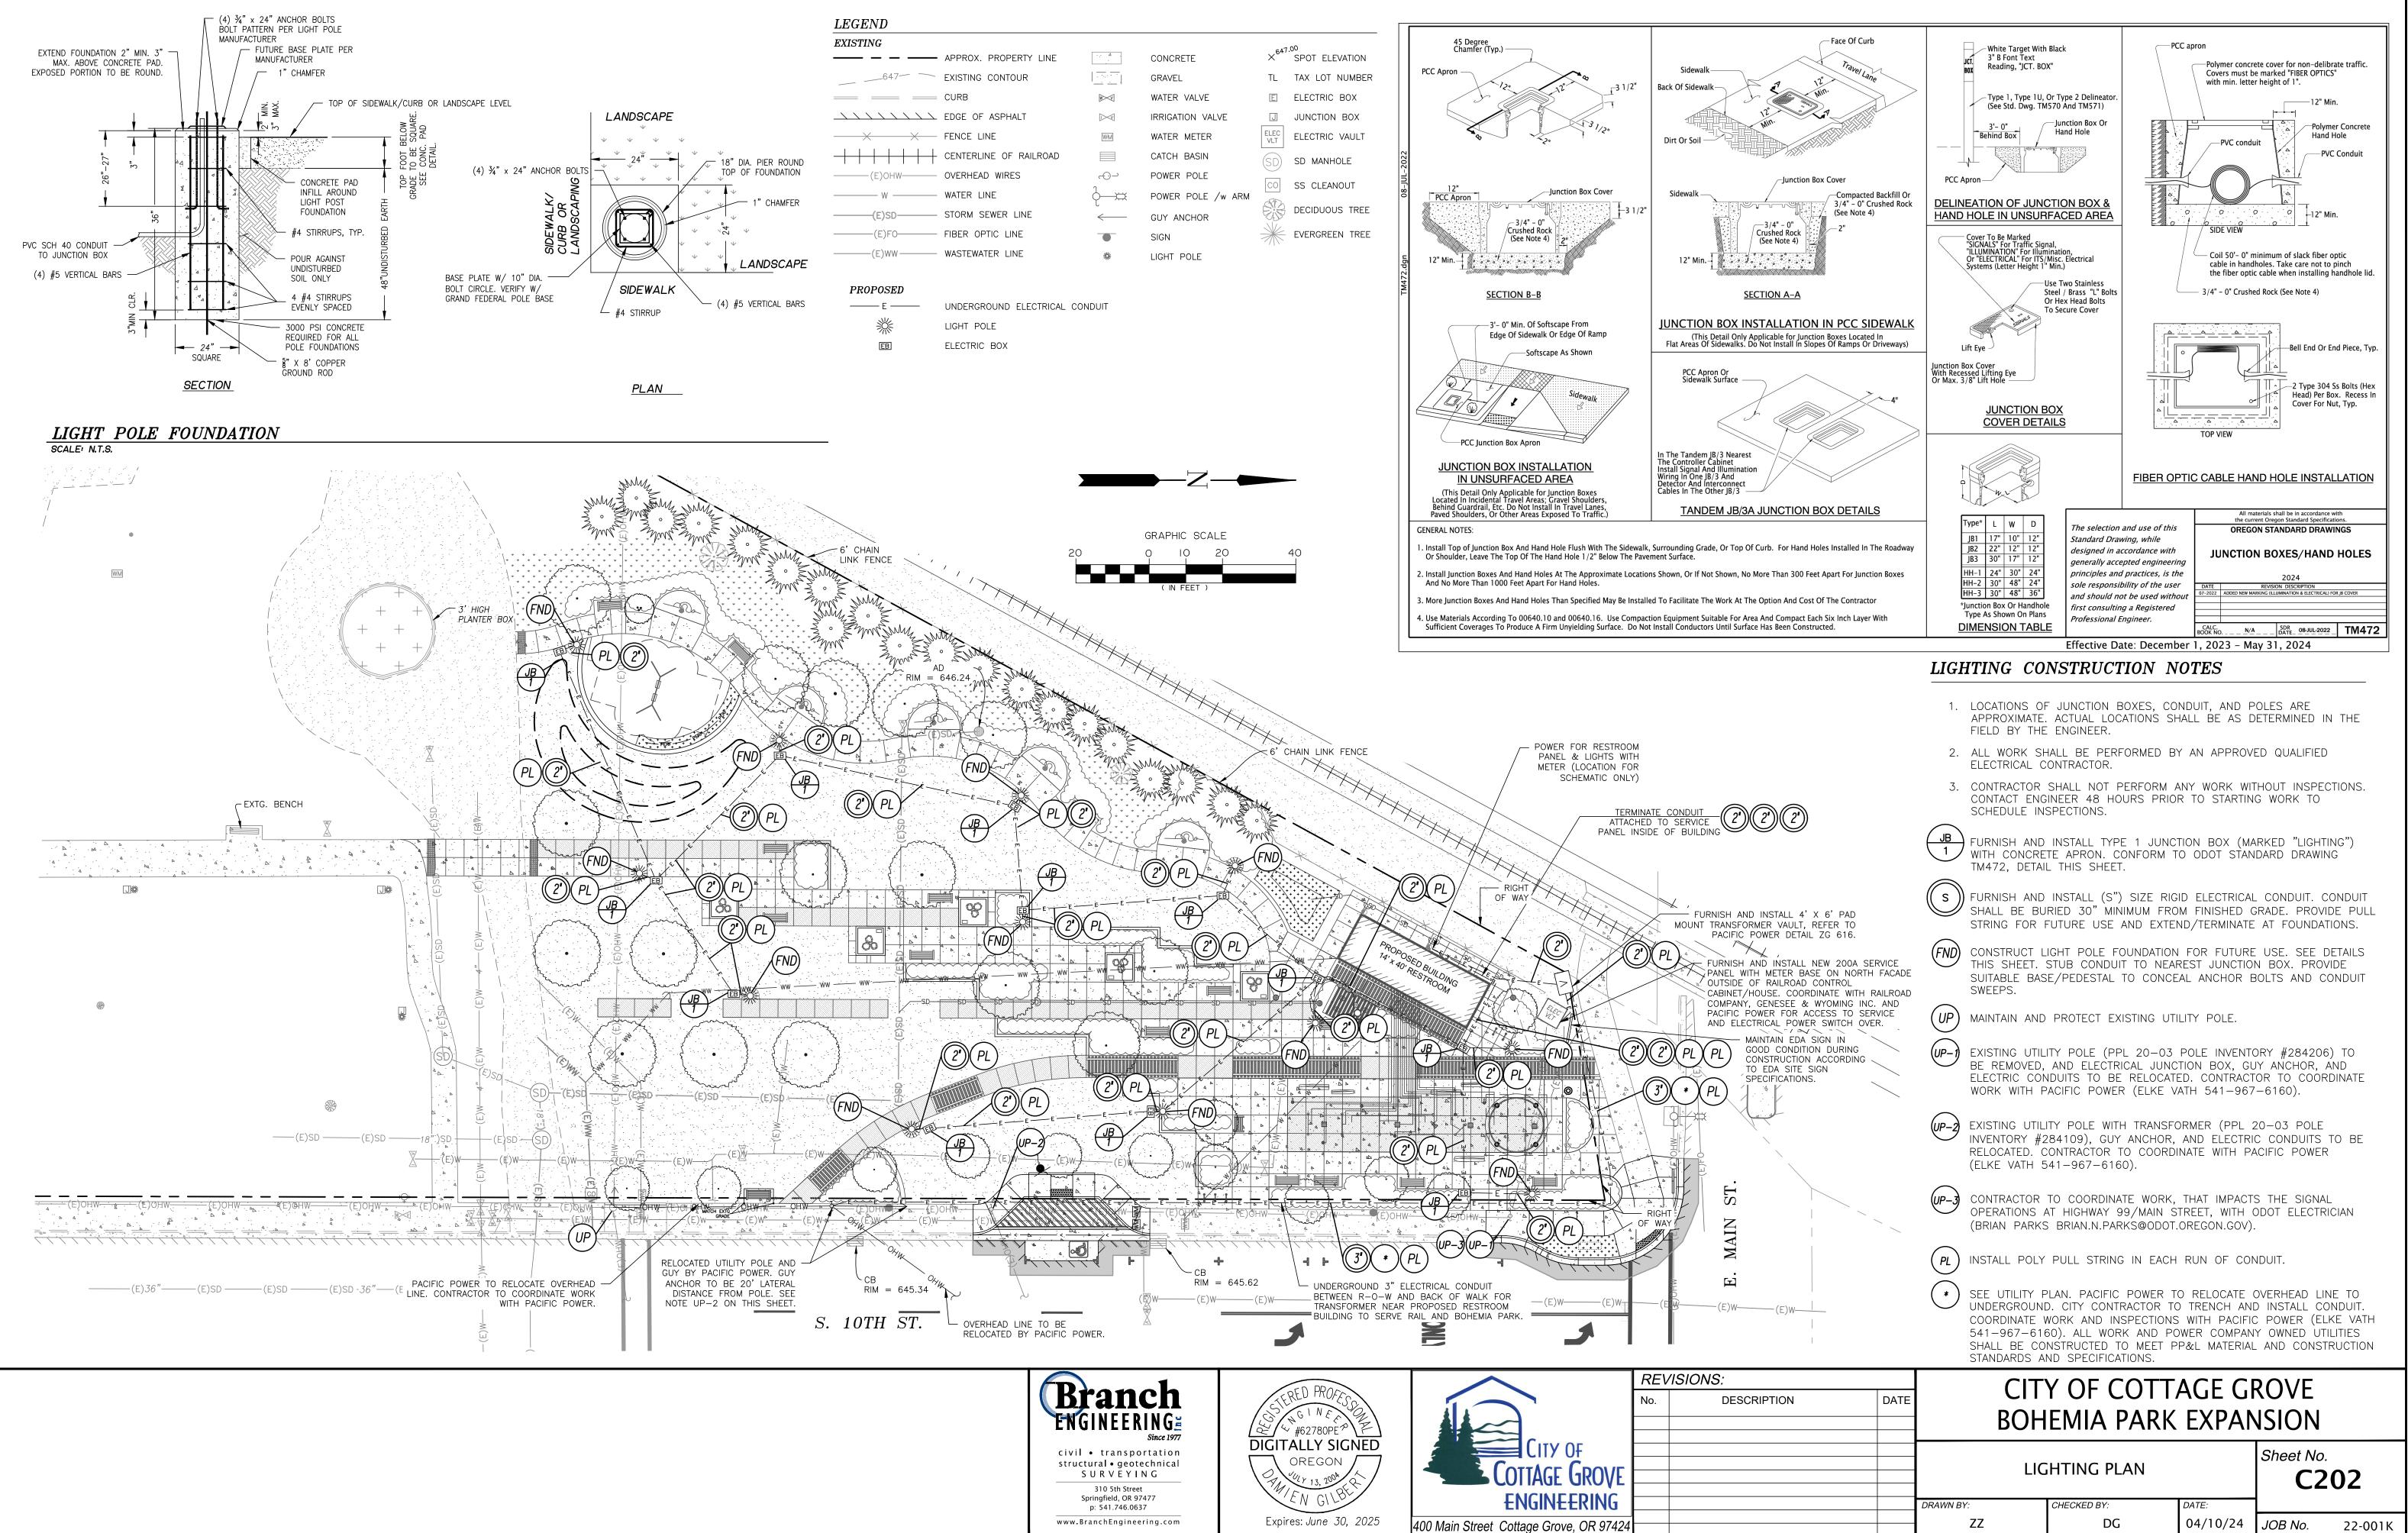


### CONSTRUCTION NOTES

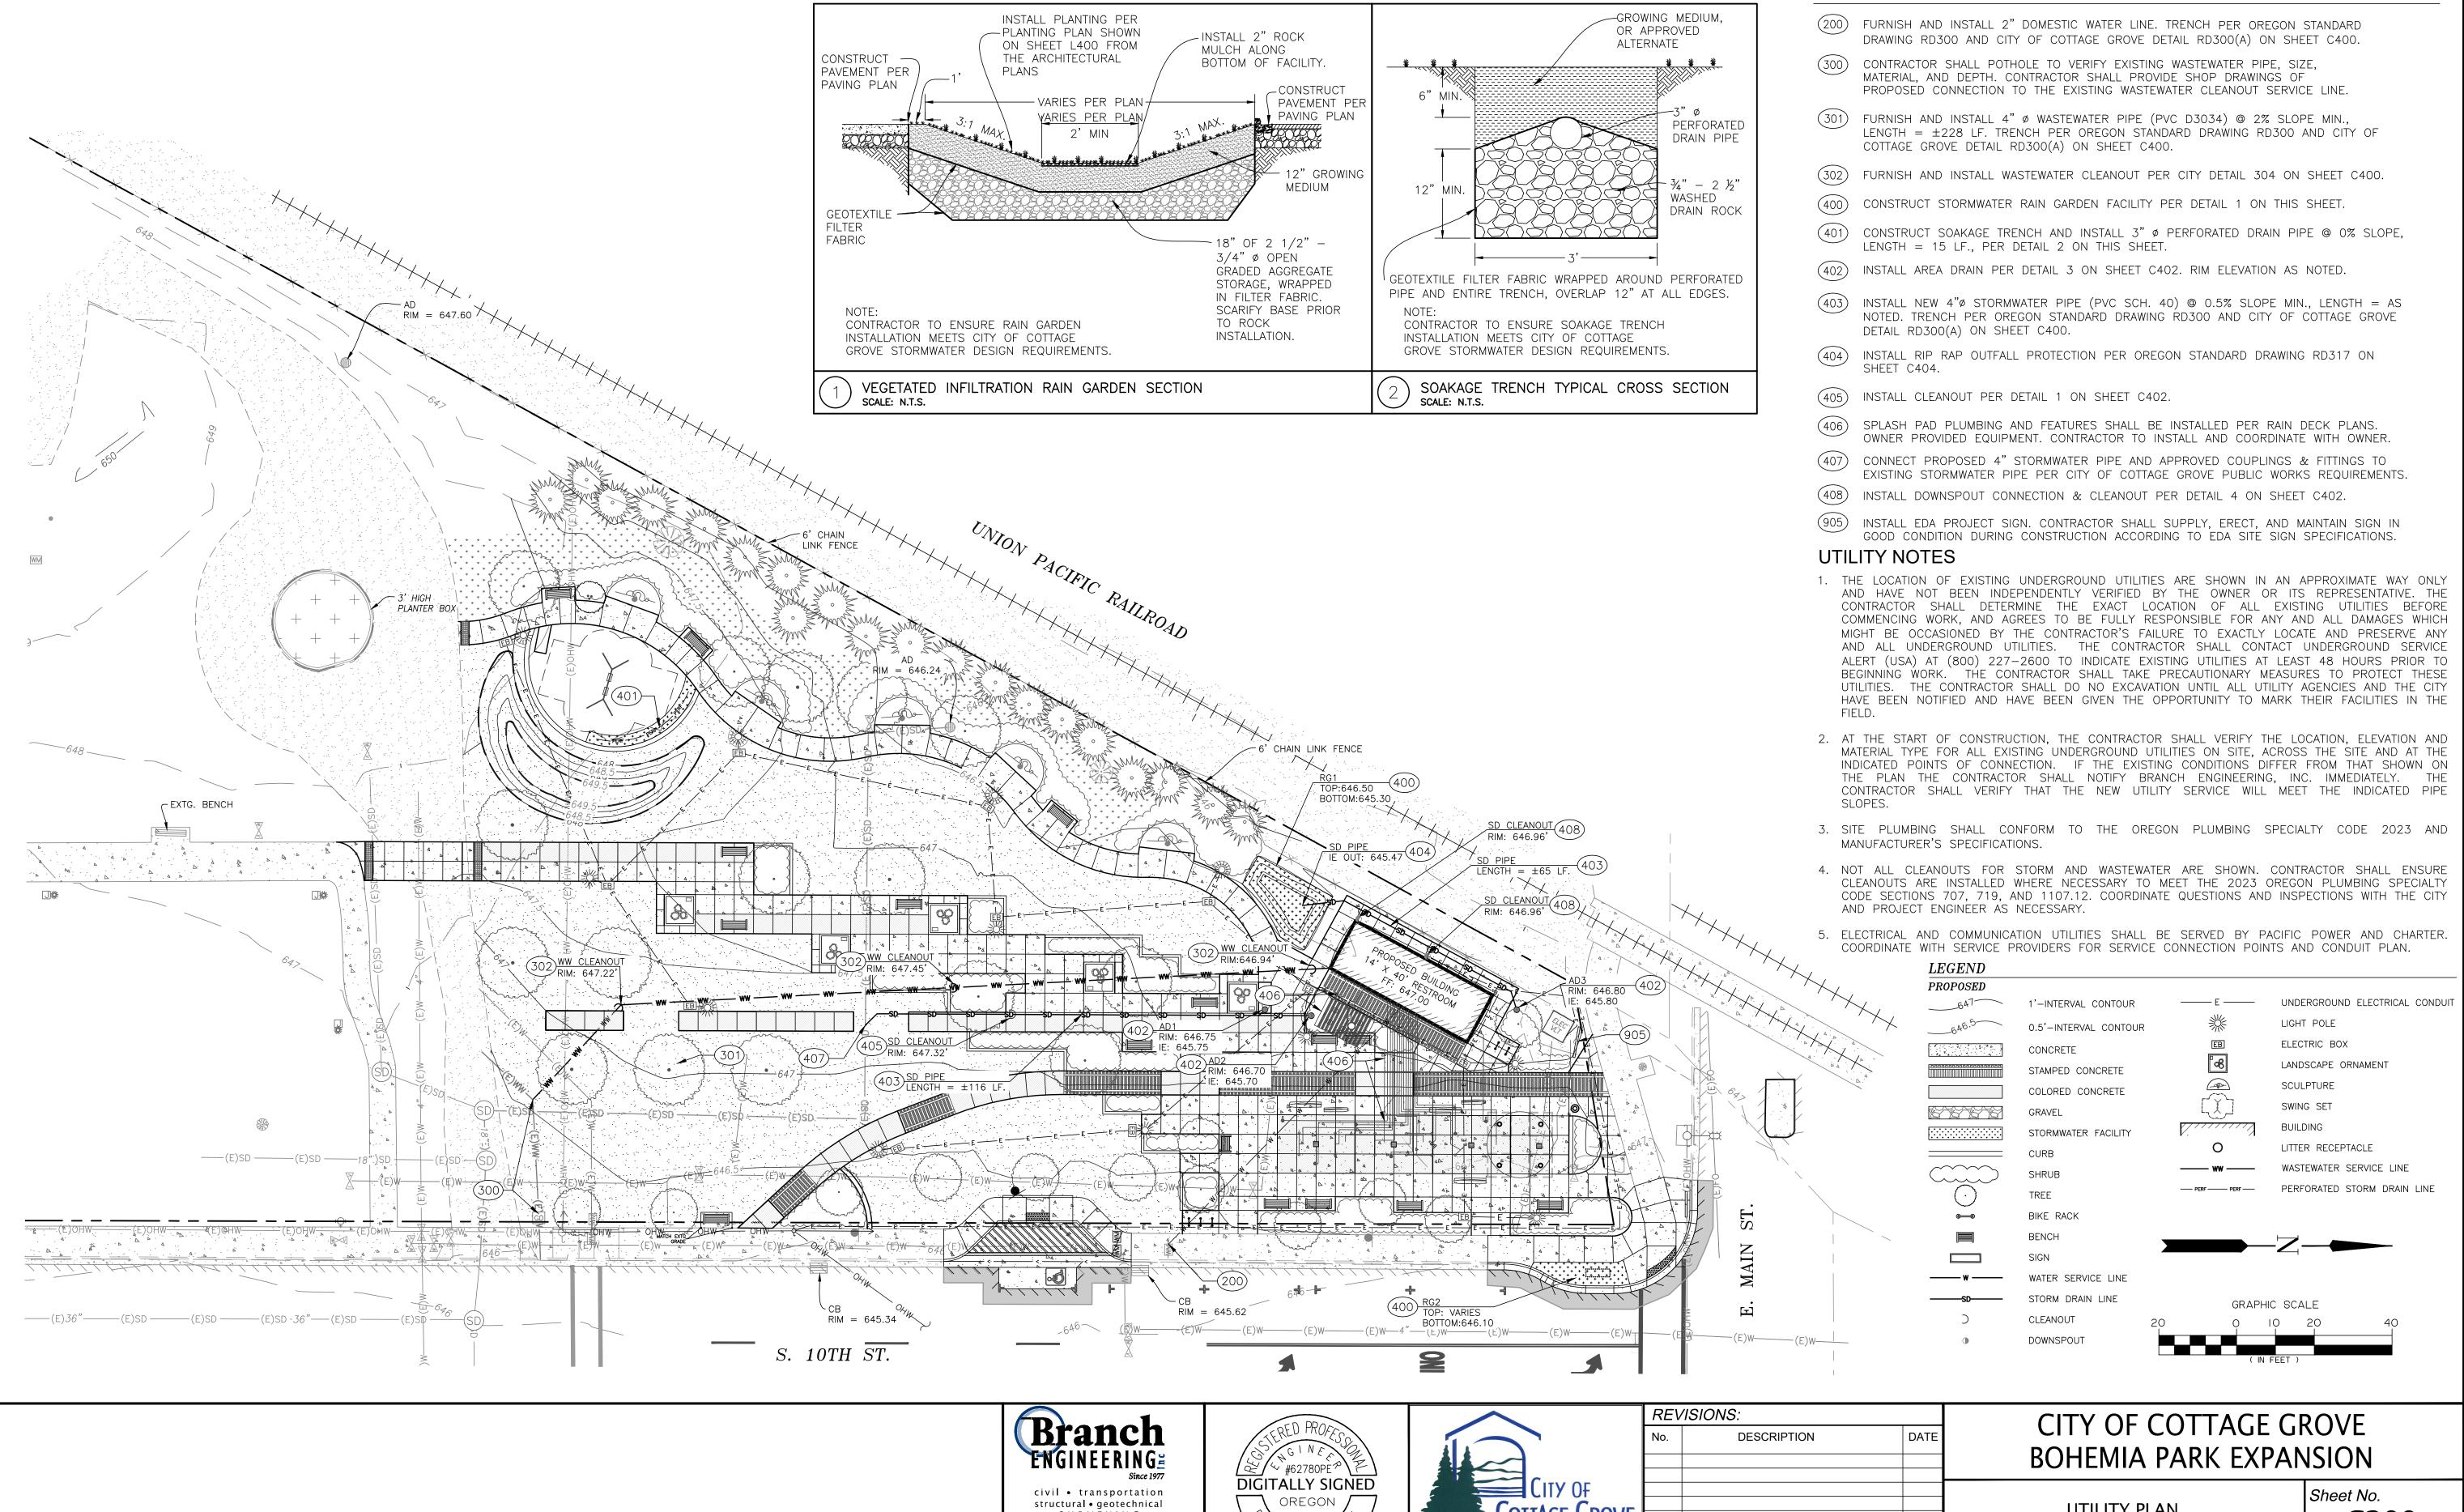
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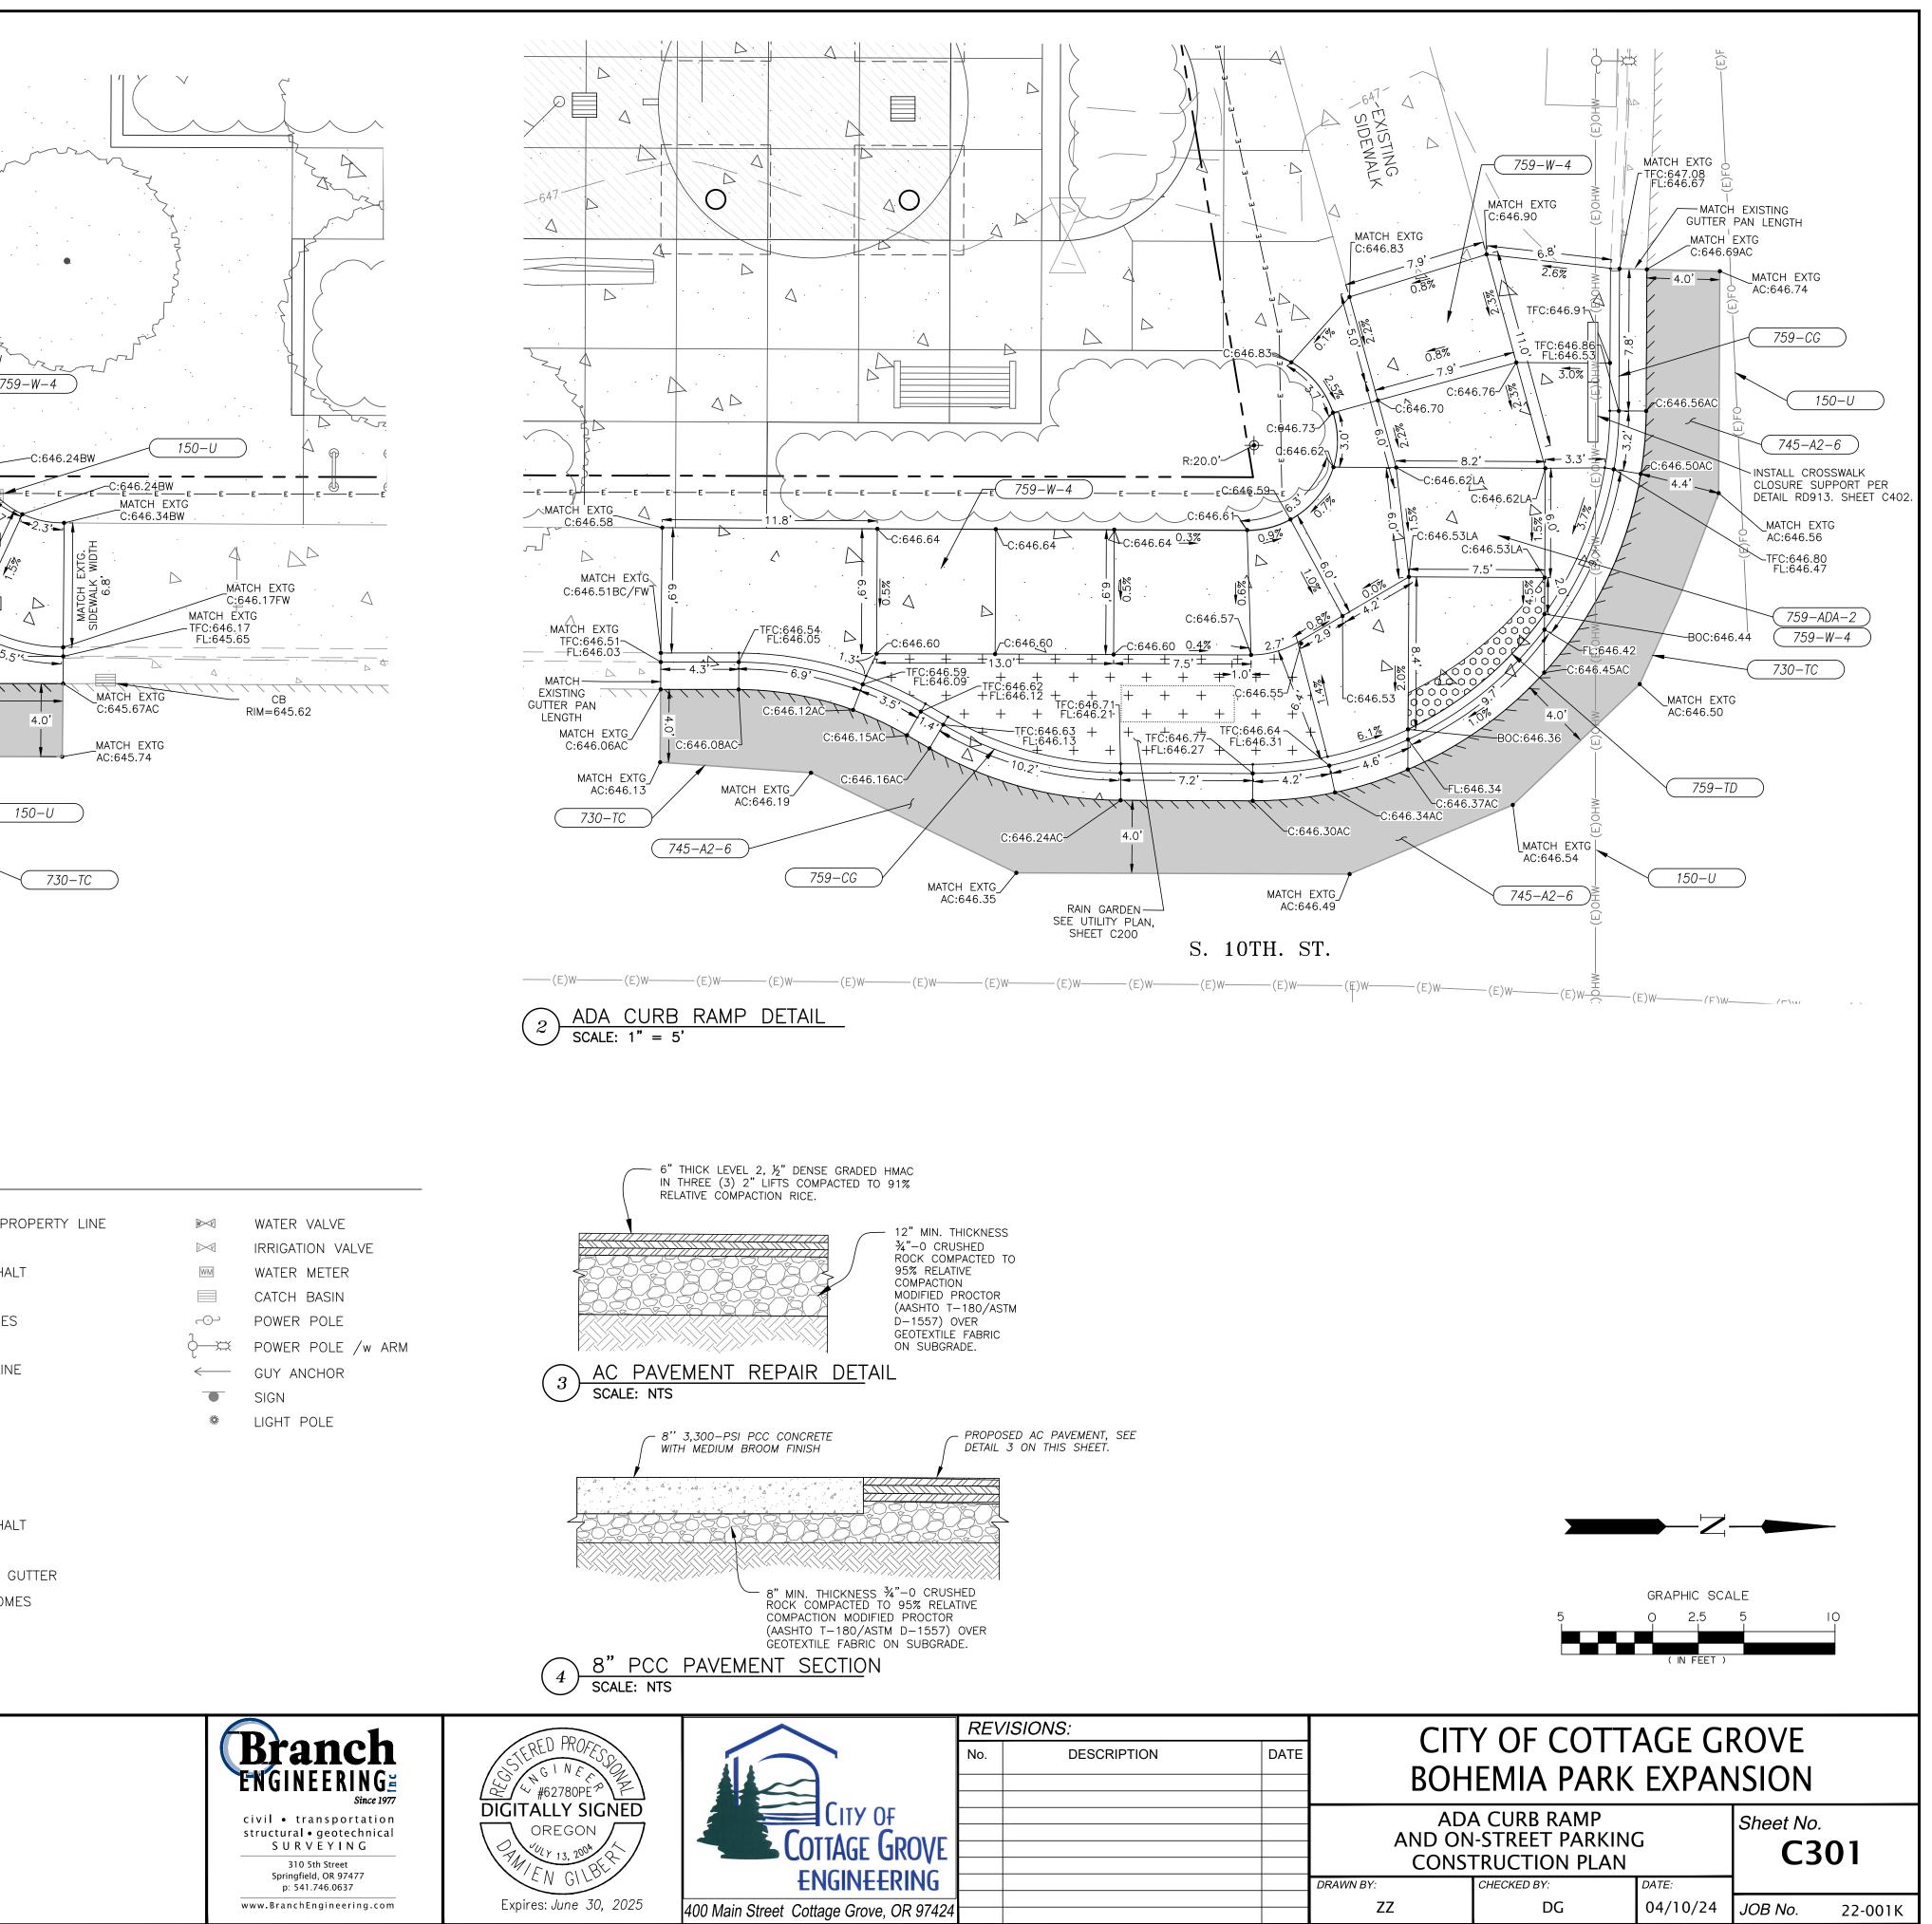


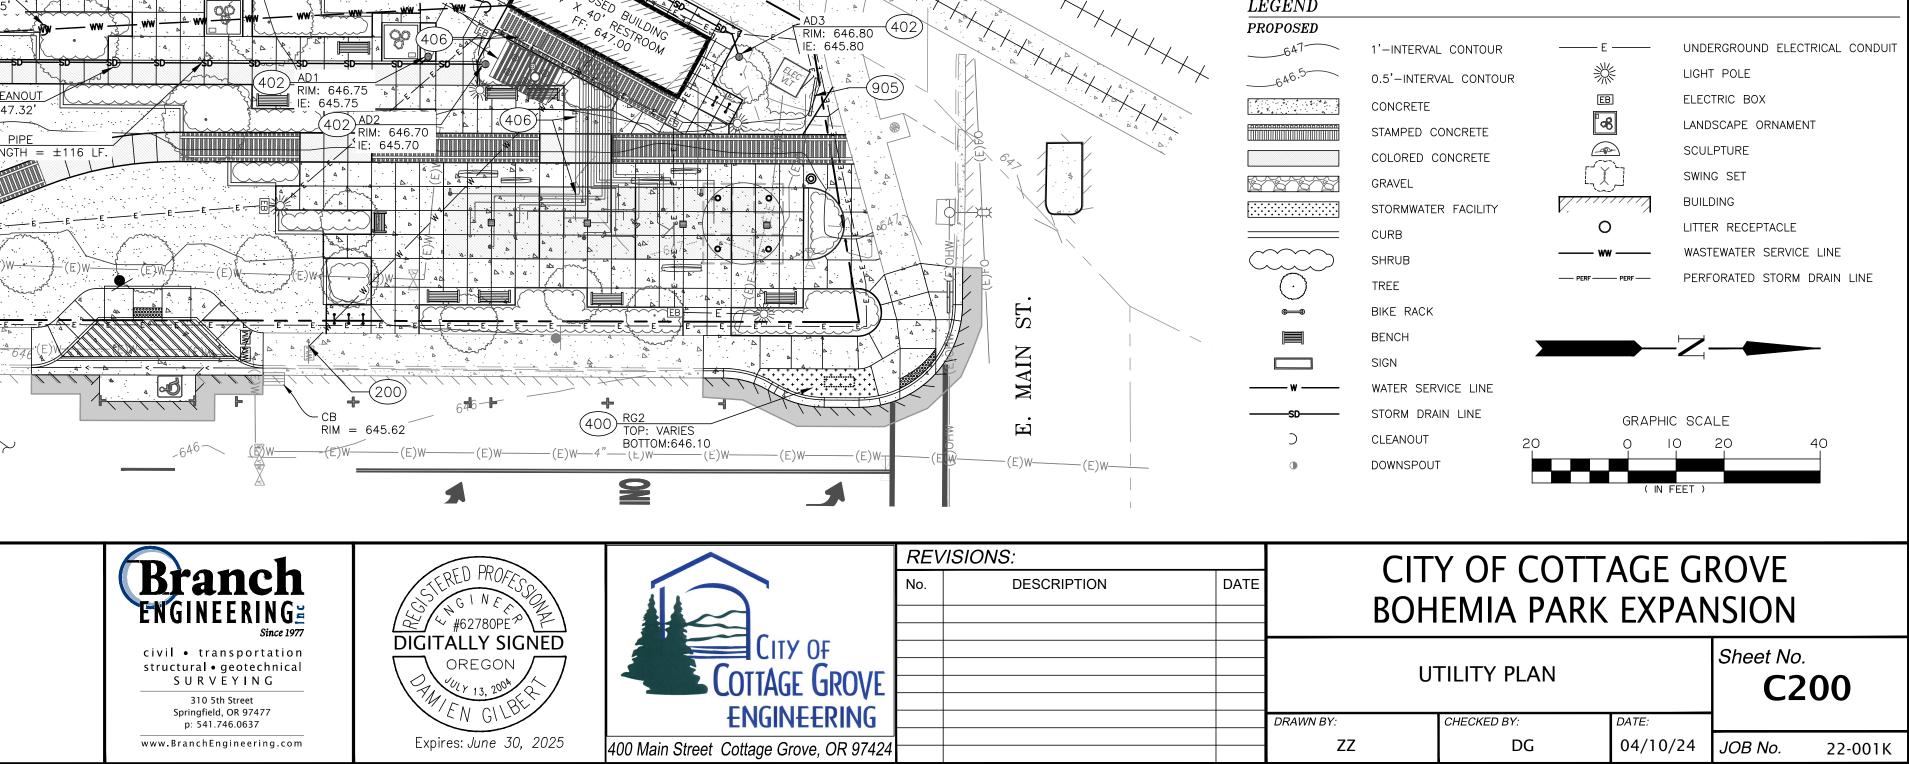
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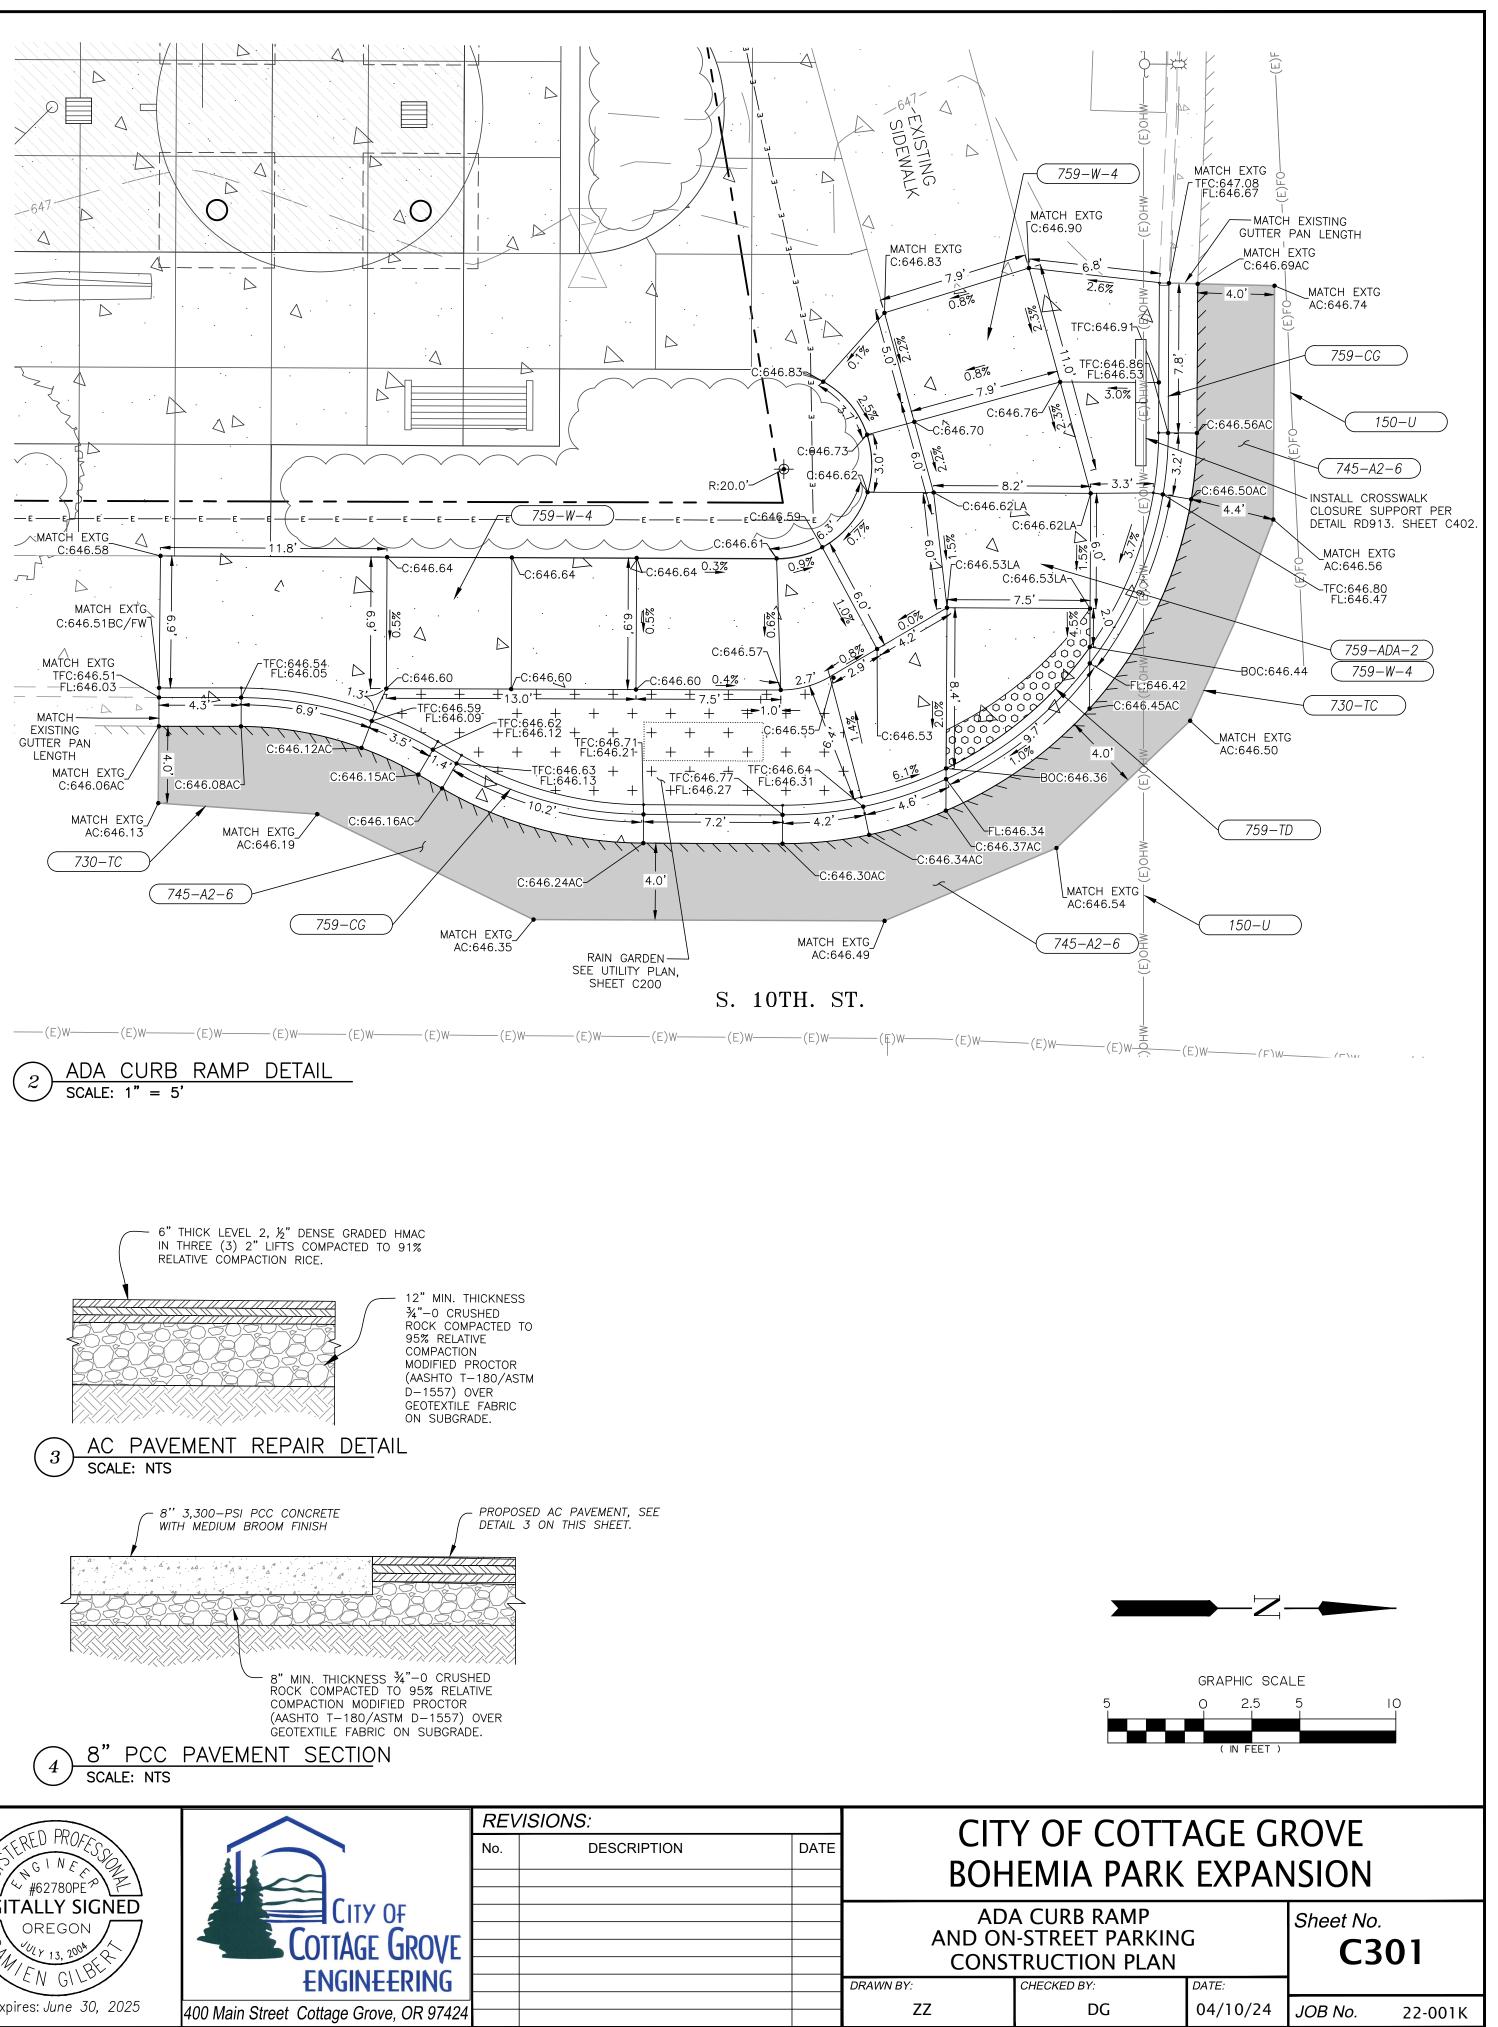



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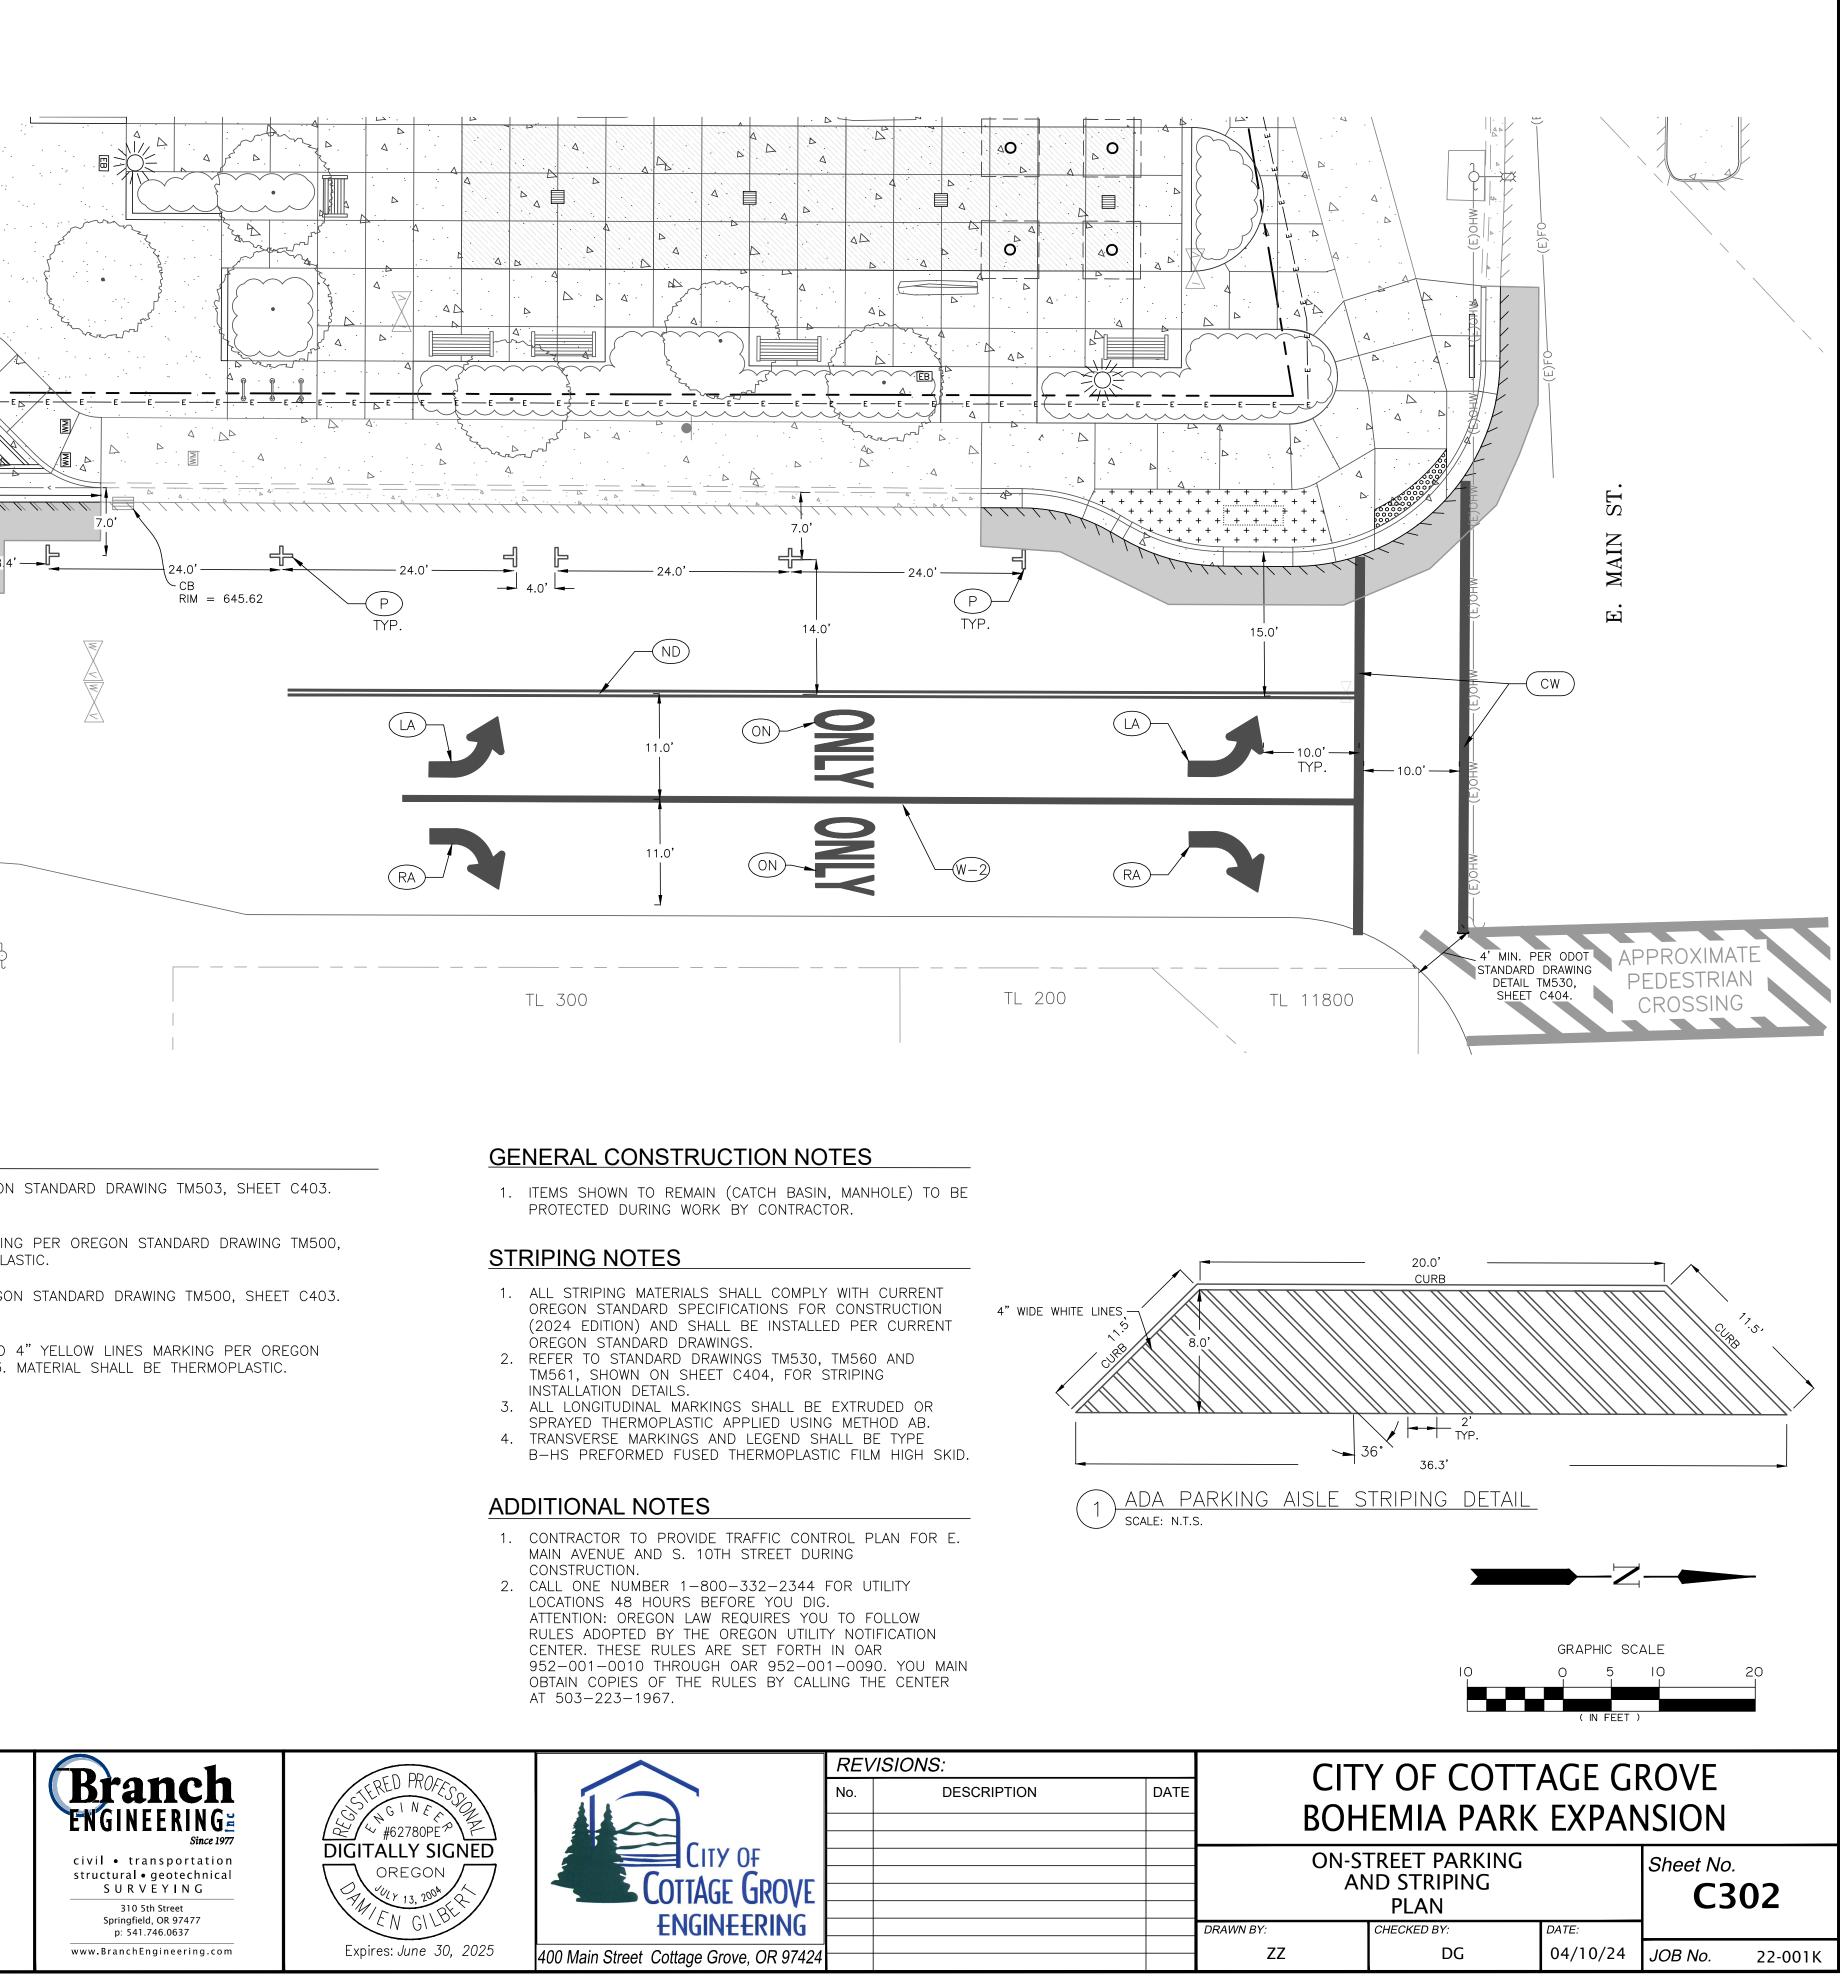
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MATC C:64	C:646.08BW C: C:646.08BW	C:646.21BW <u>7-4</u> 646.14BW 1.0'	6.11FW	₹1.0°		6.0'- C:645.71FW, C:646.15F	0 9 ₩ ₩ ₩ - C:646.16F₩ 0 0	C:646.25BW
	× Q		5.0, 0.3 TFC:646.0 F4:645.5 C:646.05FW	FL:645.61 -C:645.51 -FL:645.49 -C:645.49	5' FL:645.69 5' 759−TL 0' <u>5</u>	TFC:64 FL:64 759-CV-6	6.16 1.0' 5.66 TFC:646.15 FL:645.65 C:645.60 FL:645.59	C:646.14FW
<u>730-TC</u> M	MATCH EXTG C:645.46AC ATCH EXTG AC:645.53	MATCH EXTG AC:645.55	4.0'	-C:645.51	20.0"	- 759-W-8 C/AC:645	C:645.60	TFC:646.14 FL:645.64 14.1' MATCH EXTG AC:645.73 150
Of Mr.	759-VG		MATCH EXTG AC:645.65	745	-A2-6			MATCH EXTG AC:645.87
$\sim 0_{H_{W_k}}$	STRFFT ADA	PARKING DET	NHO		S. 10T	H. ST.		
I SCALE:	1" = 5'		<u>/ ((</u>					
	PROTECT EXISTING	G UTILITY. ADJUST E	30X TO FINISHE	ED GRADE AS N	IEEDED.			
	SAND OVER EXIST	JOINT. APPLY TACK FING PAVEMENT EDG NG RD302 ON SHEE	ES PER OREGO					
(745-A2-6)	THICKNESS, WHIC	EVEL 2, ½" DENSE H HEVER IS GREATER, GROVE DETAIL RD3 ON SHEET C400.	SEE DETAIL 3	ON THIS SHEE	ΞΤ,		LEGEND	
(759-ADA-1)-	SHEET C402, MO	RAMP PER OREGON DIFIED PER DETAIL HAVE CITY INSPECT	1 SHOWN ON	THIS SHEET.			EXISTING	– APPROXIMATE PROF = CURB
(759-ADA-2)-	C402, MODIFIED	RAMP PER OREGON PER DETAIL 2 SHOV CTOR APPROVE FOR	VN ON THIS SH	HEET. CONTRACT	FOR TO		647	► EDGE OF ASPHALT CONTOUR LINE
	CRUSHED ROCK	HICK CONCRETE SID PER DETAIL 1 AND ON SHEET C400.					(E)OHW	
(759-W-8)		HICK CONCRETE PAV PER DETAIL 4 ON T		8" THICK ¾"-0			· · · · · · · · · · · · · · · · · · ·	CONCRETE LANDSCAPE
		ED DOME TEXTURING AND RD905 ON SHI		N STANDARD			PROPOSED	CONCRETE
	RD700 ON SHEET ADA RAMP SHALL	AND GUTTER PER C401. GUTTER S NOT EXCEED 2%. A RAMP SHALL NOT	LOPE DIRECTLY COUNTER SLO	IN FRONT OF				ASPHALT EDGE OF ASPHALT
(759-CV-6)-		ONCRETE CURB, EX OREGON STANDARD						CURB CONCRETE "V" GUT
(759-VG)		IETRICAL "V" TYPE ( ON SHEET C400, M						TRUNCATED DOMES SIGN
<u>930-SS</u>	AND CONSTRUCT	ESSIBLE HANDICAP SIGN POST BASE A ). 502 SHOWN ON	ND MOUNTING					

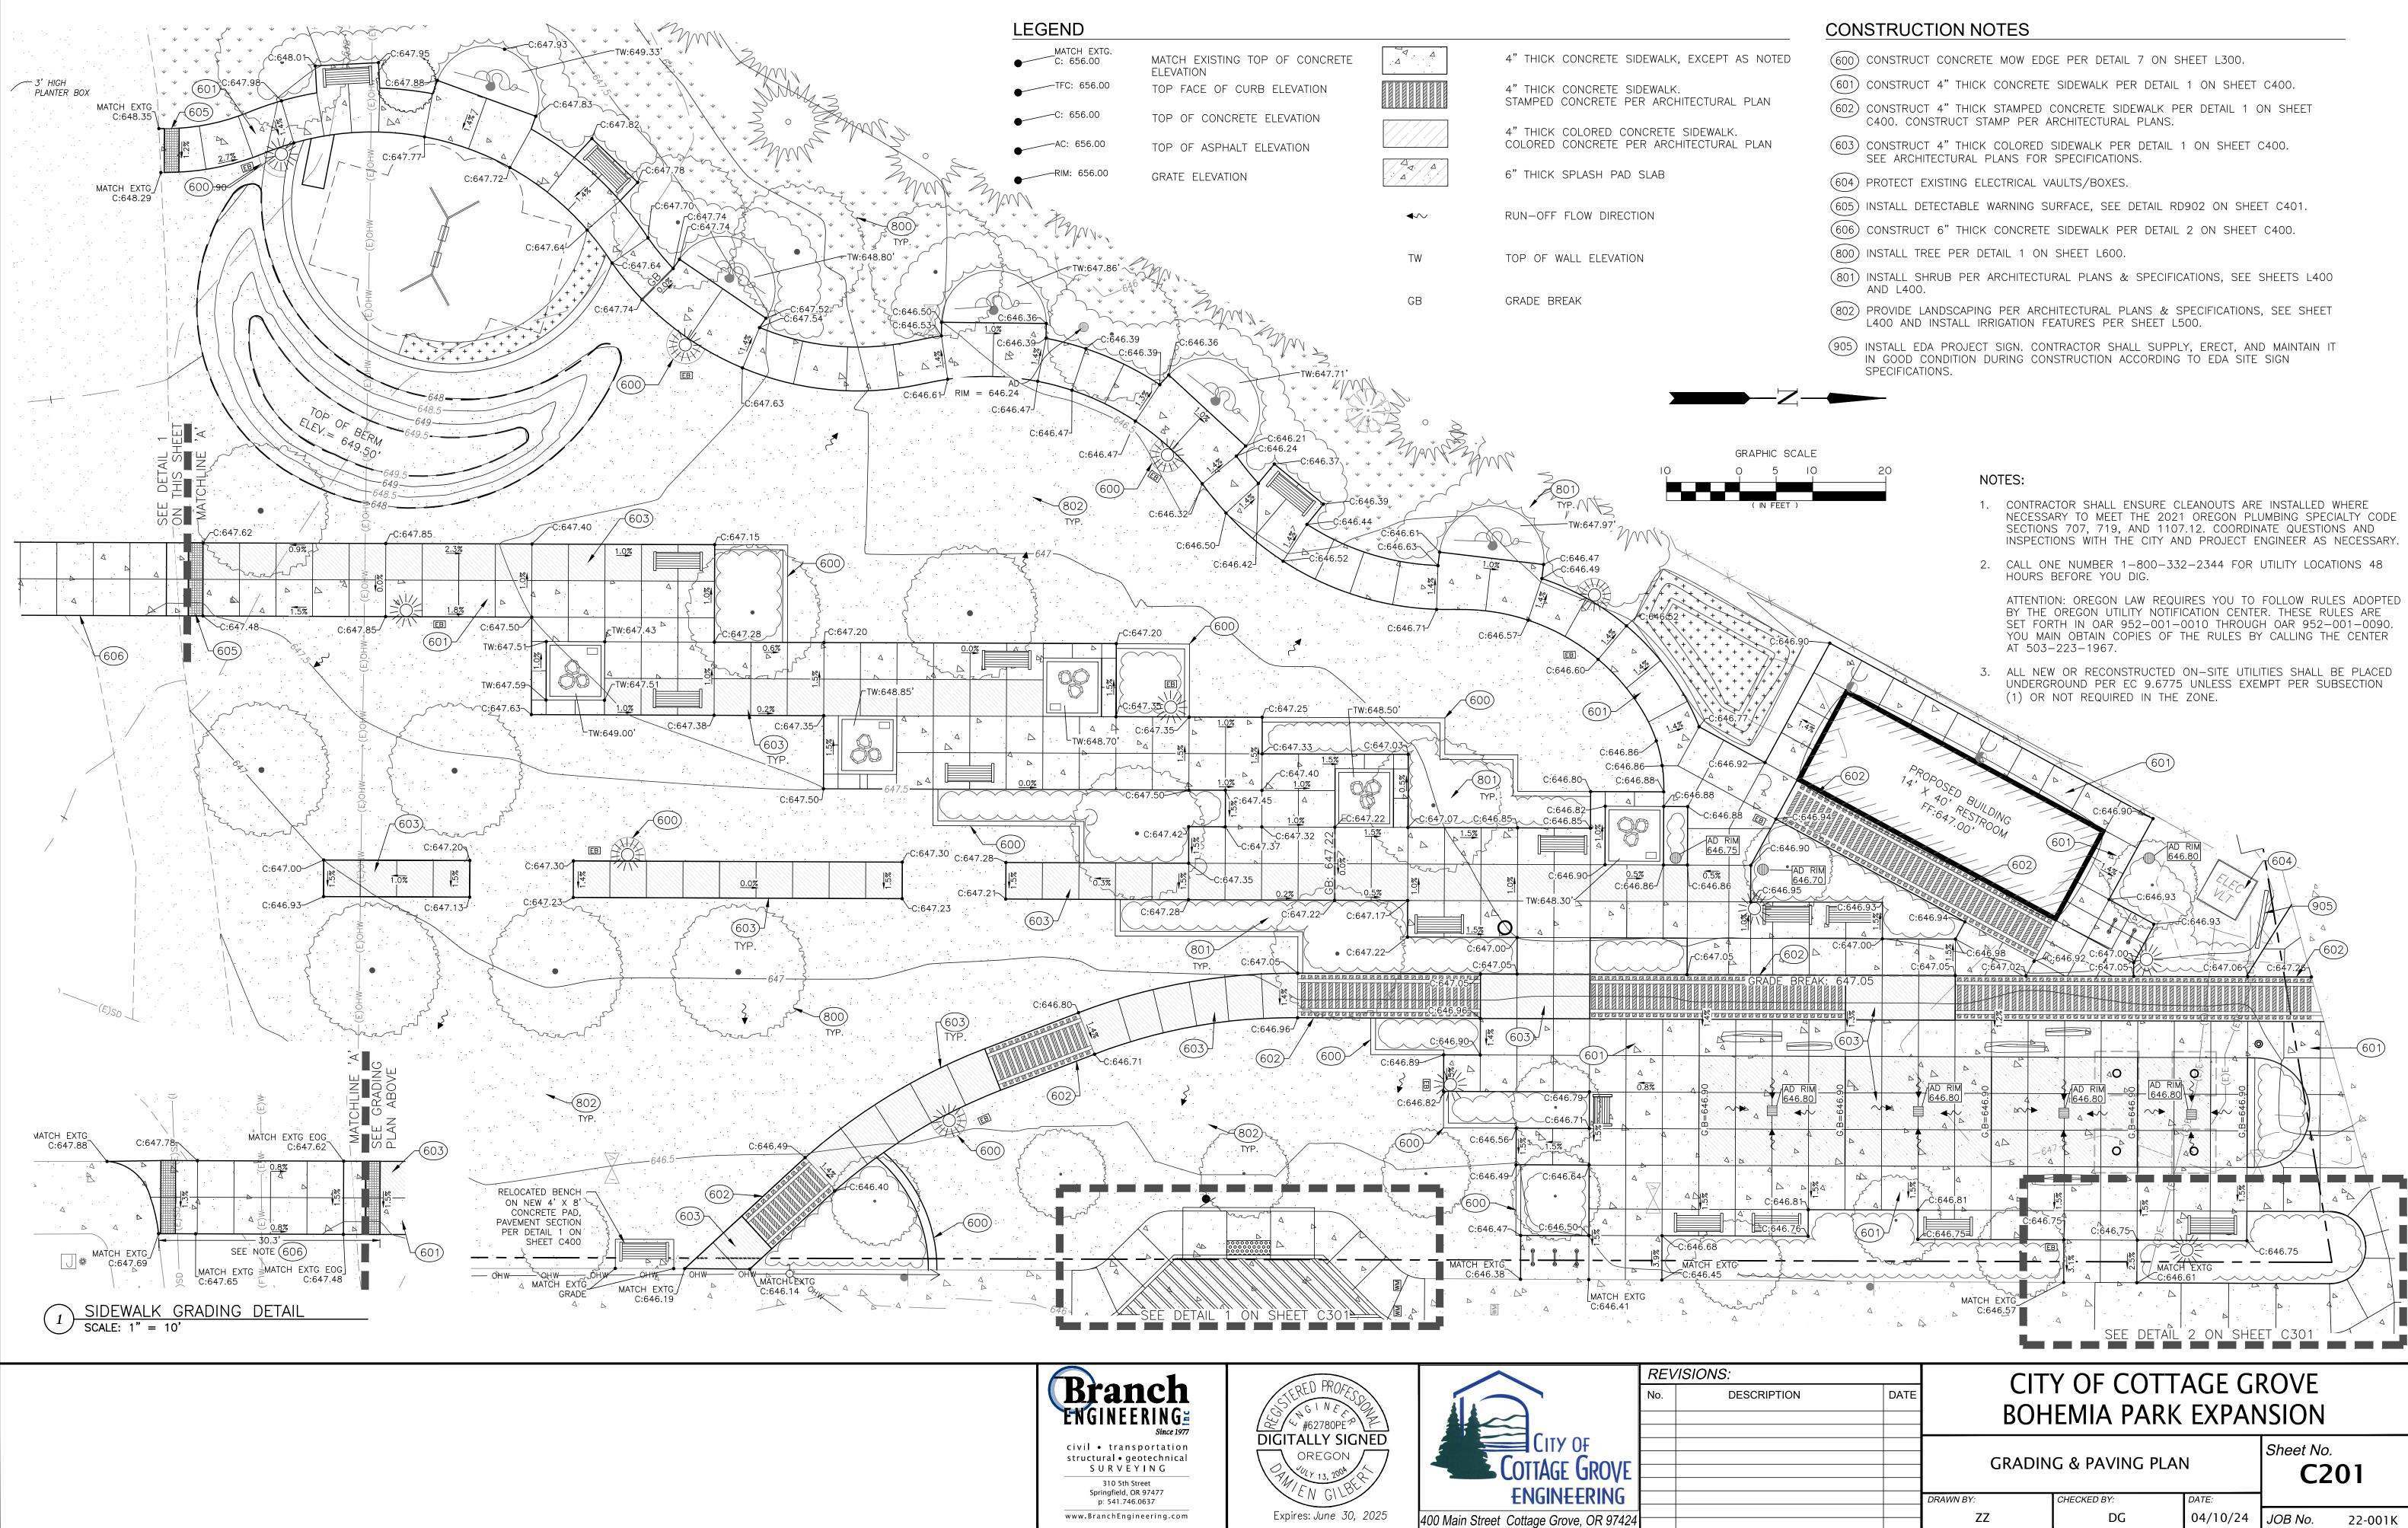




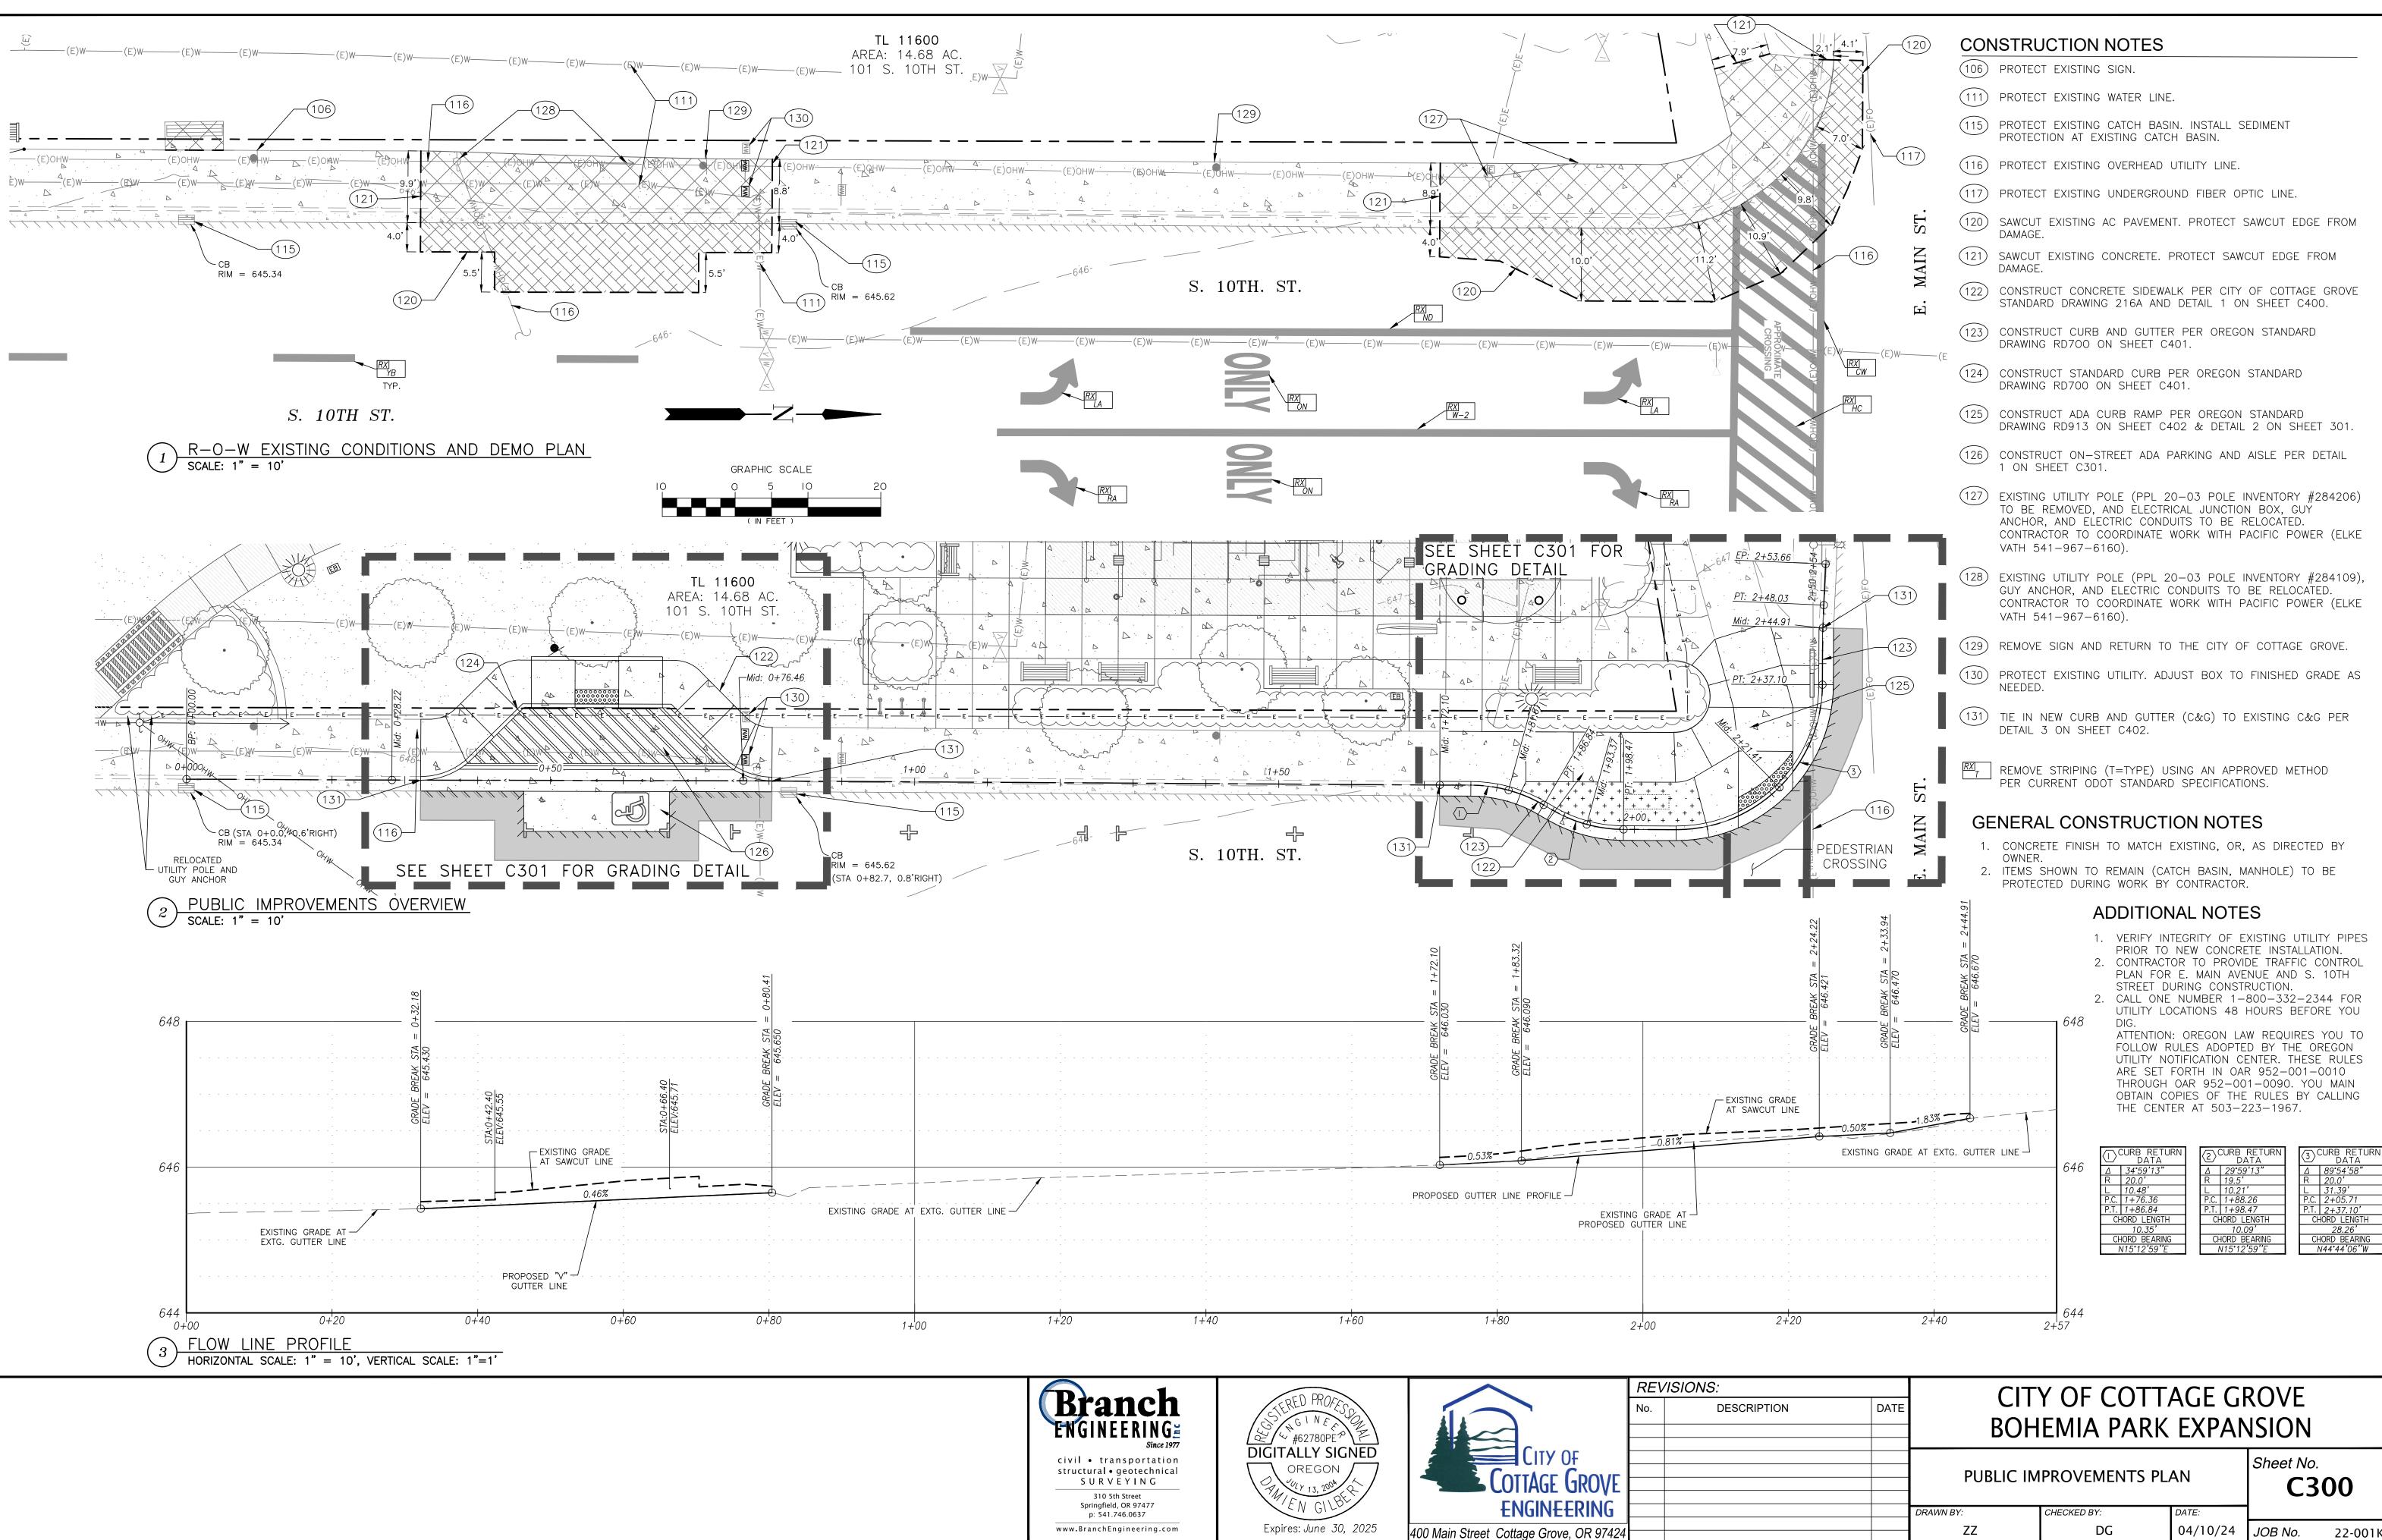


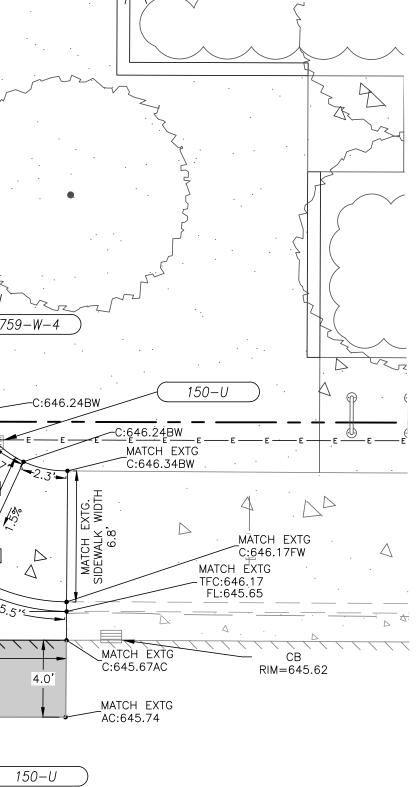


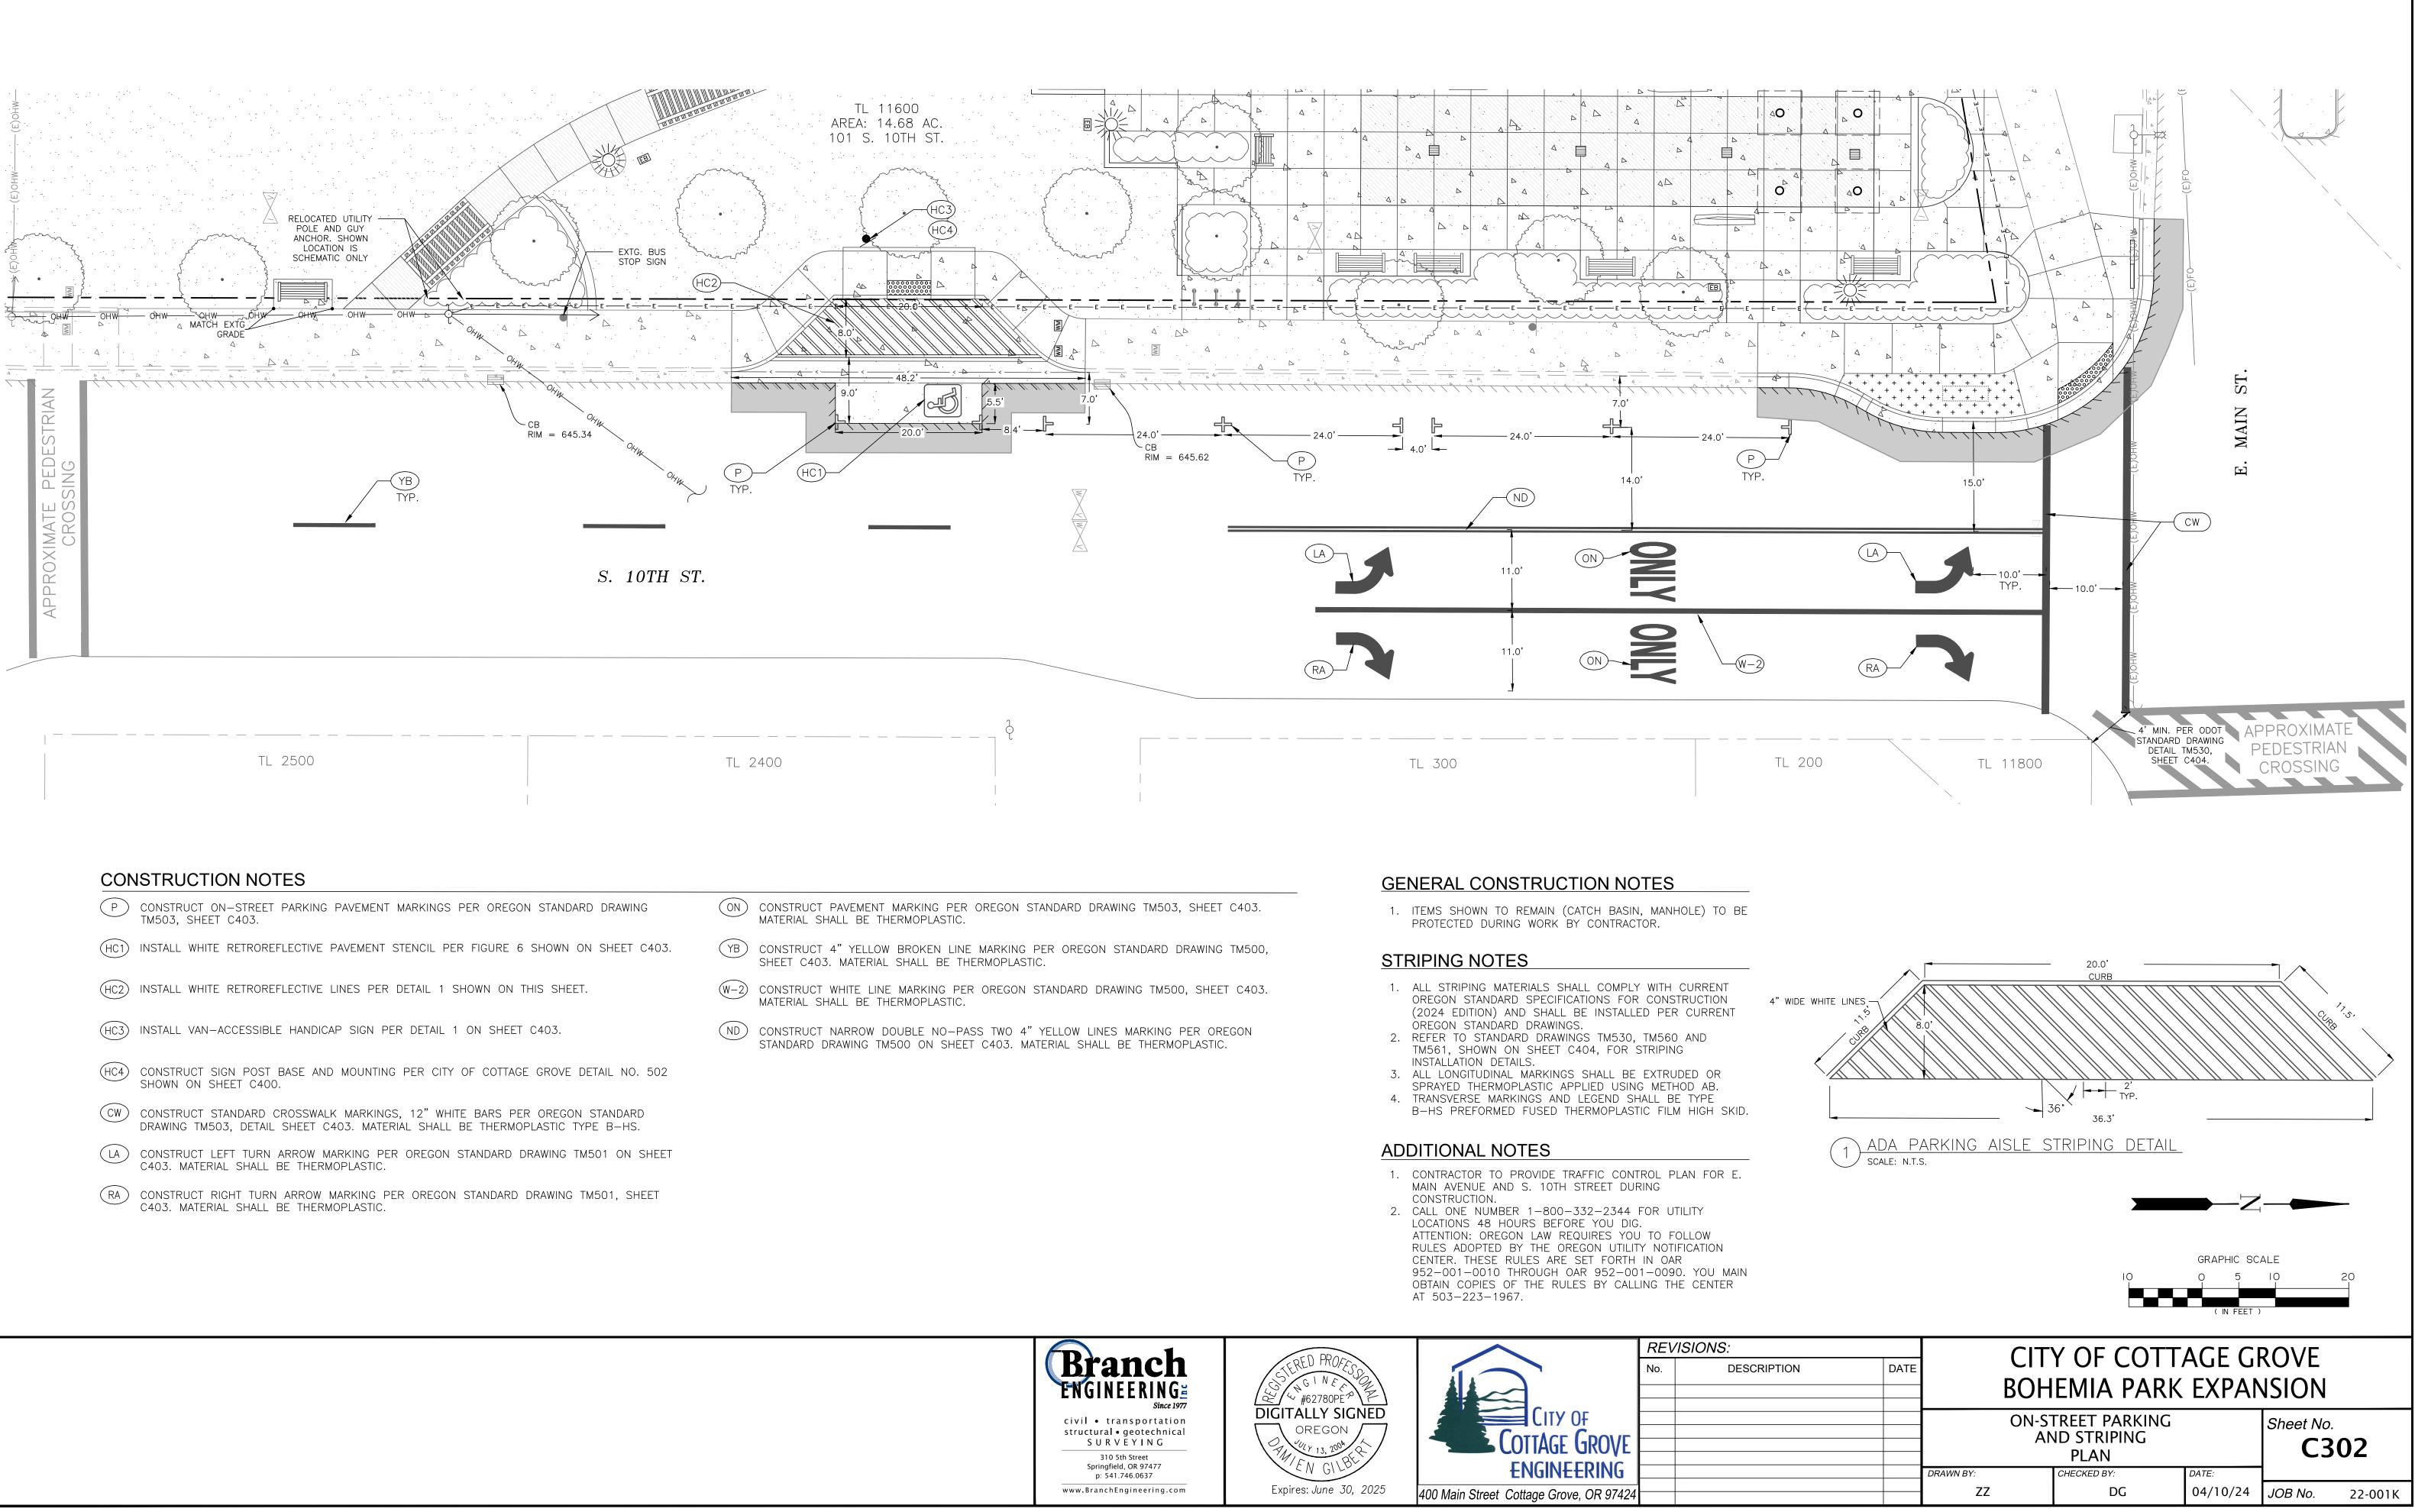


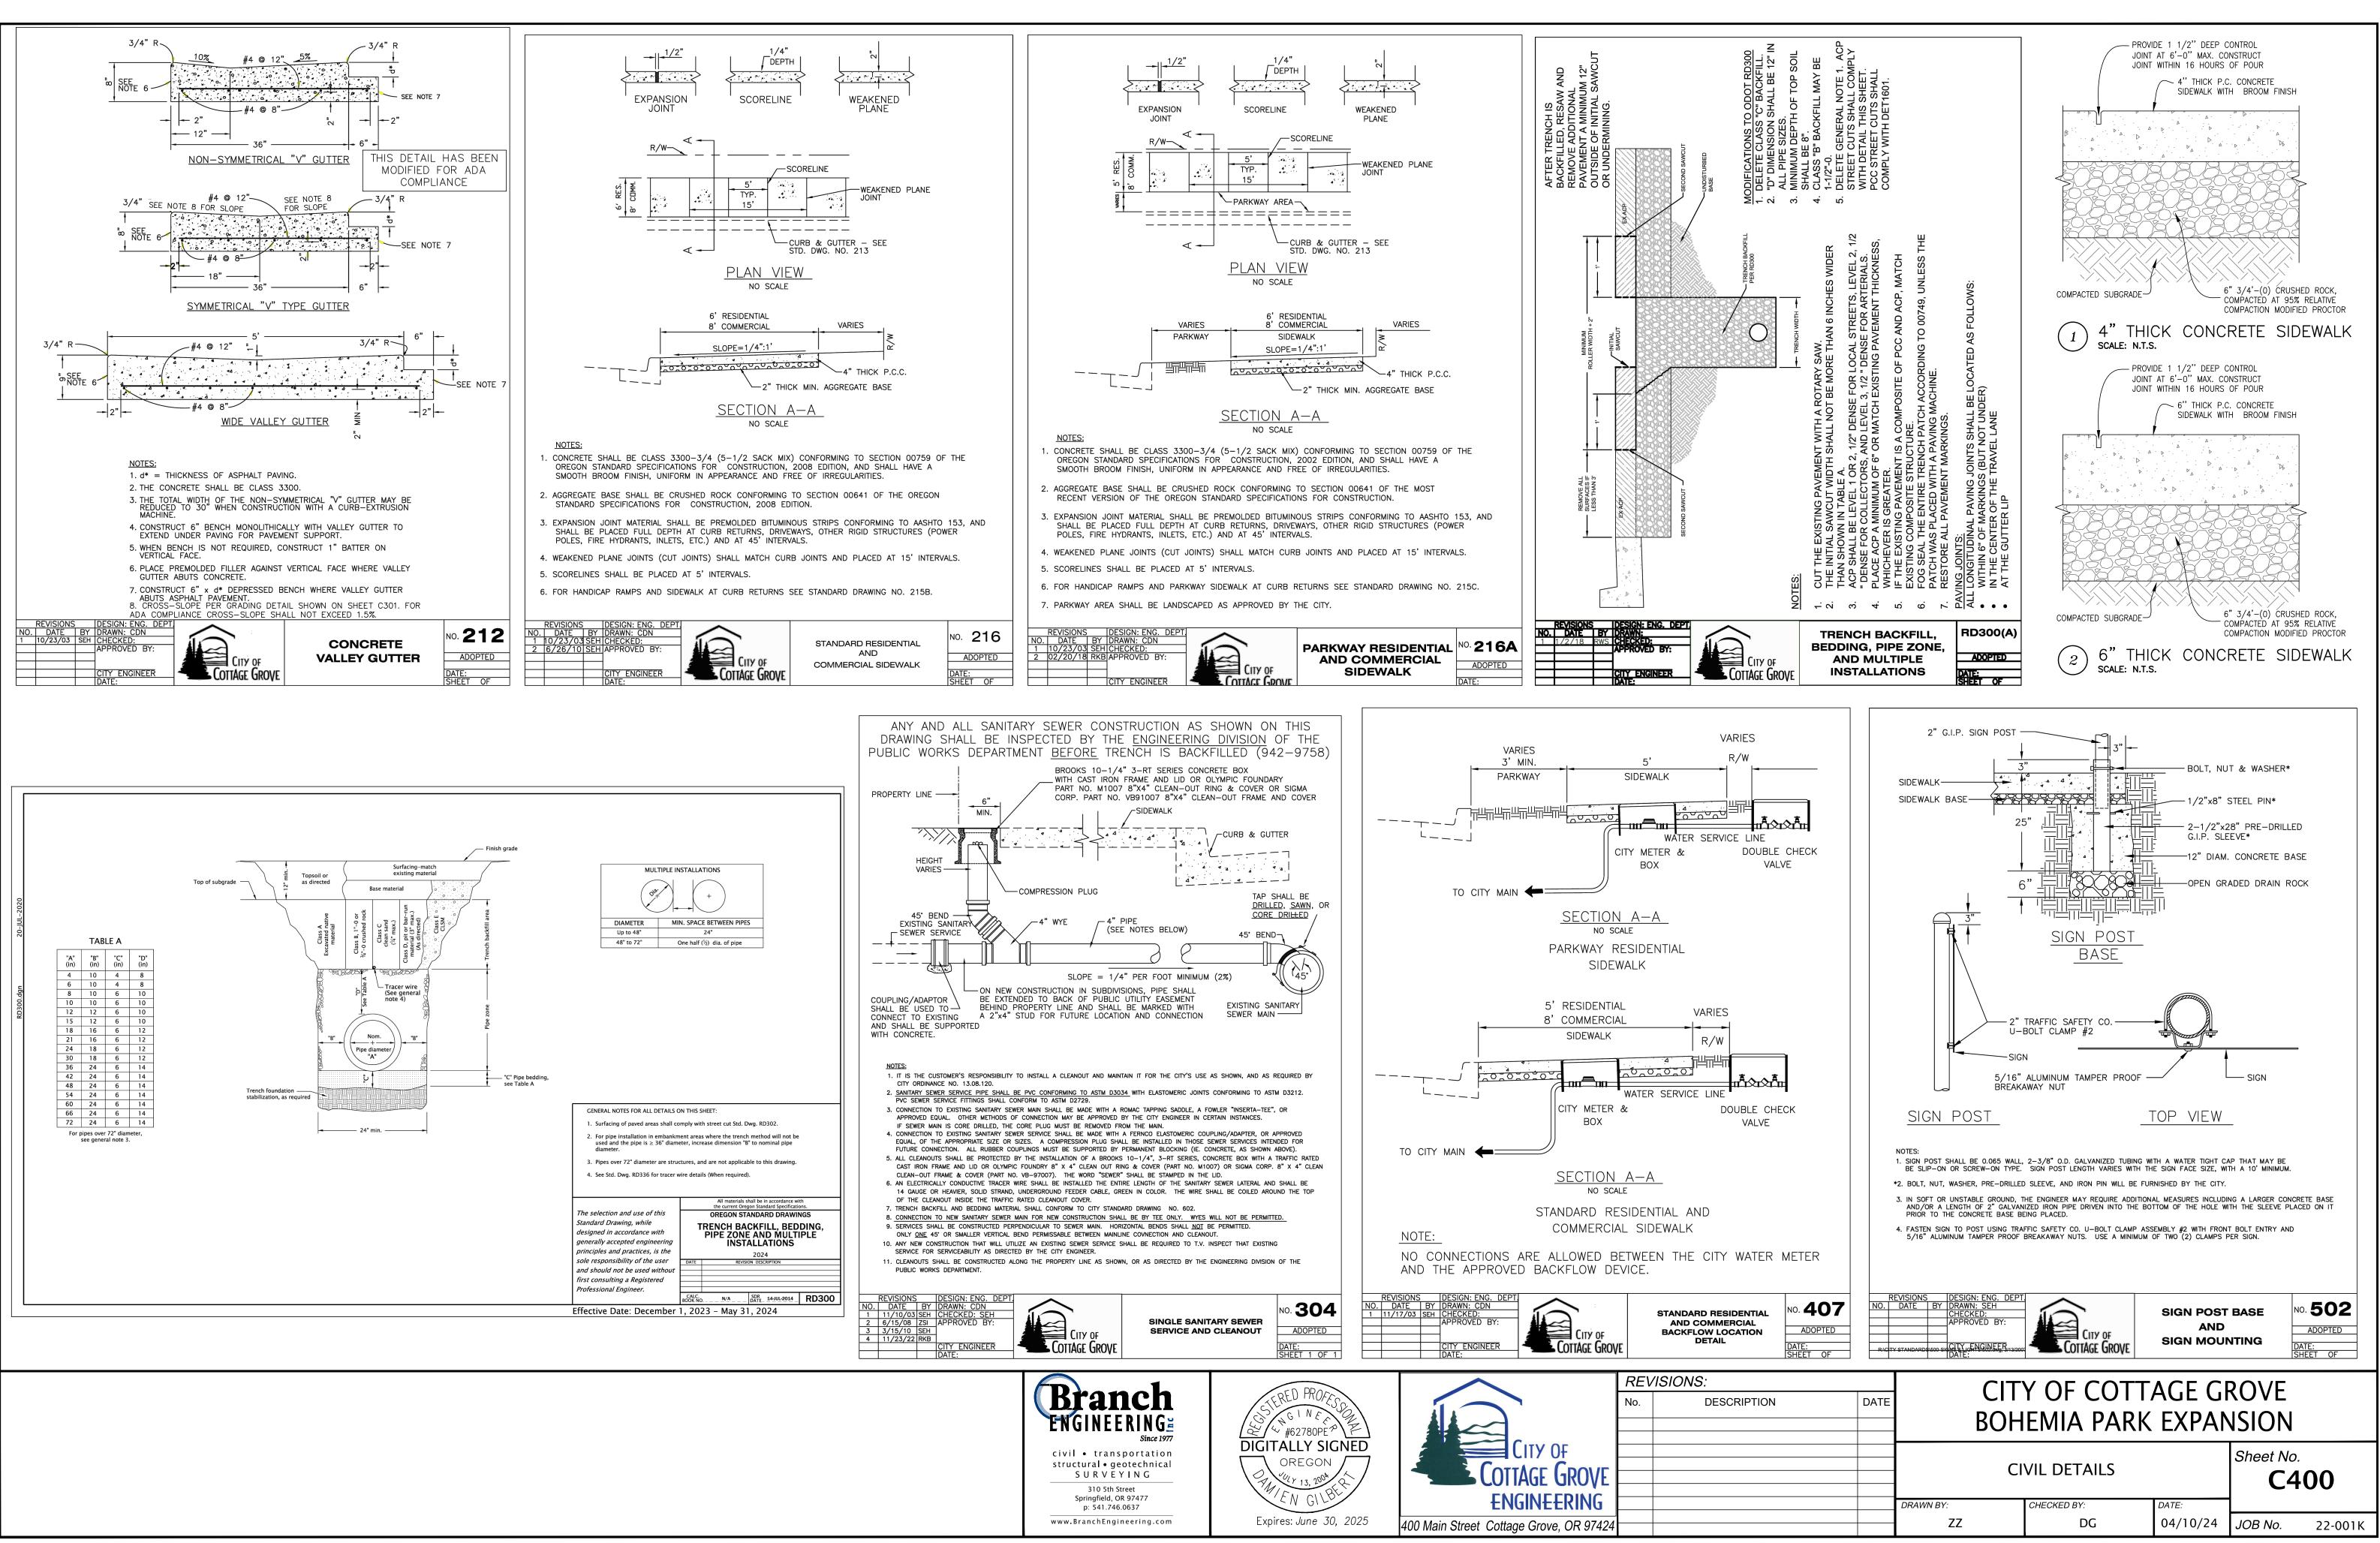

-001k Cottage Grove Bohemia Park Expansion\Drawings\100 Percent\22-001K Bohemia Park Expansion\_041024\_100%.dwg 4/11/2024 8.

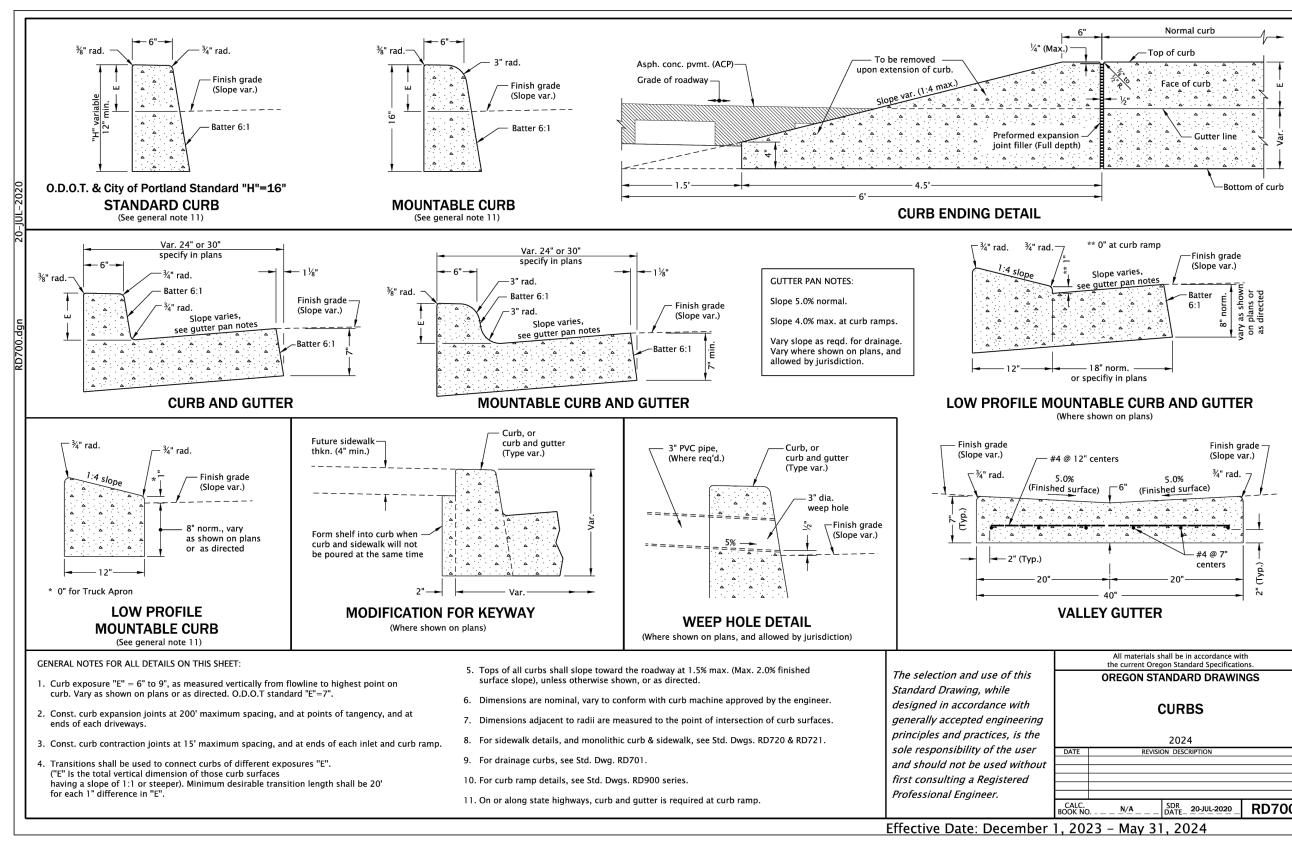

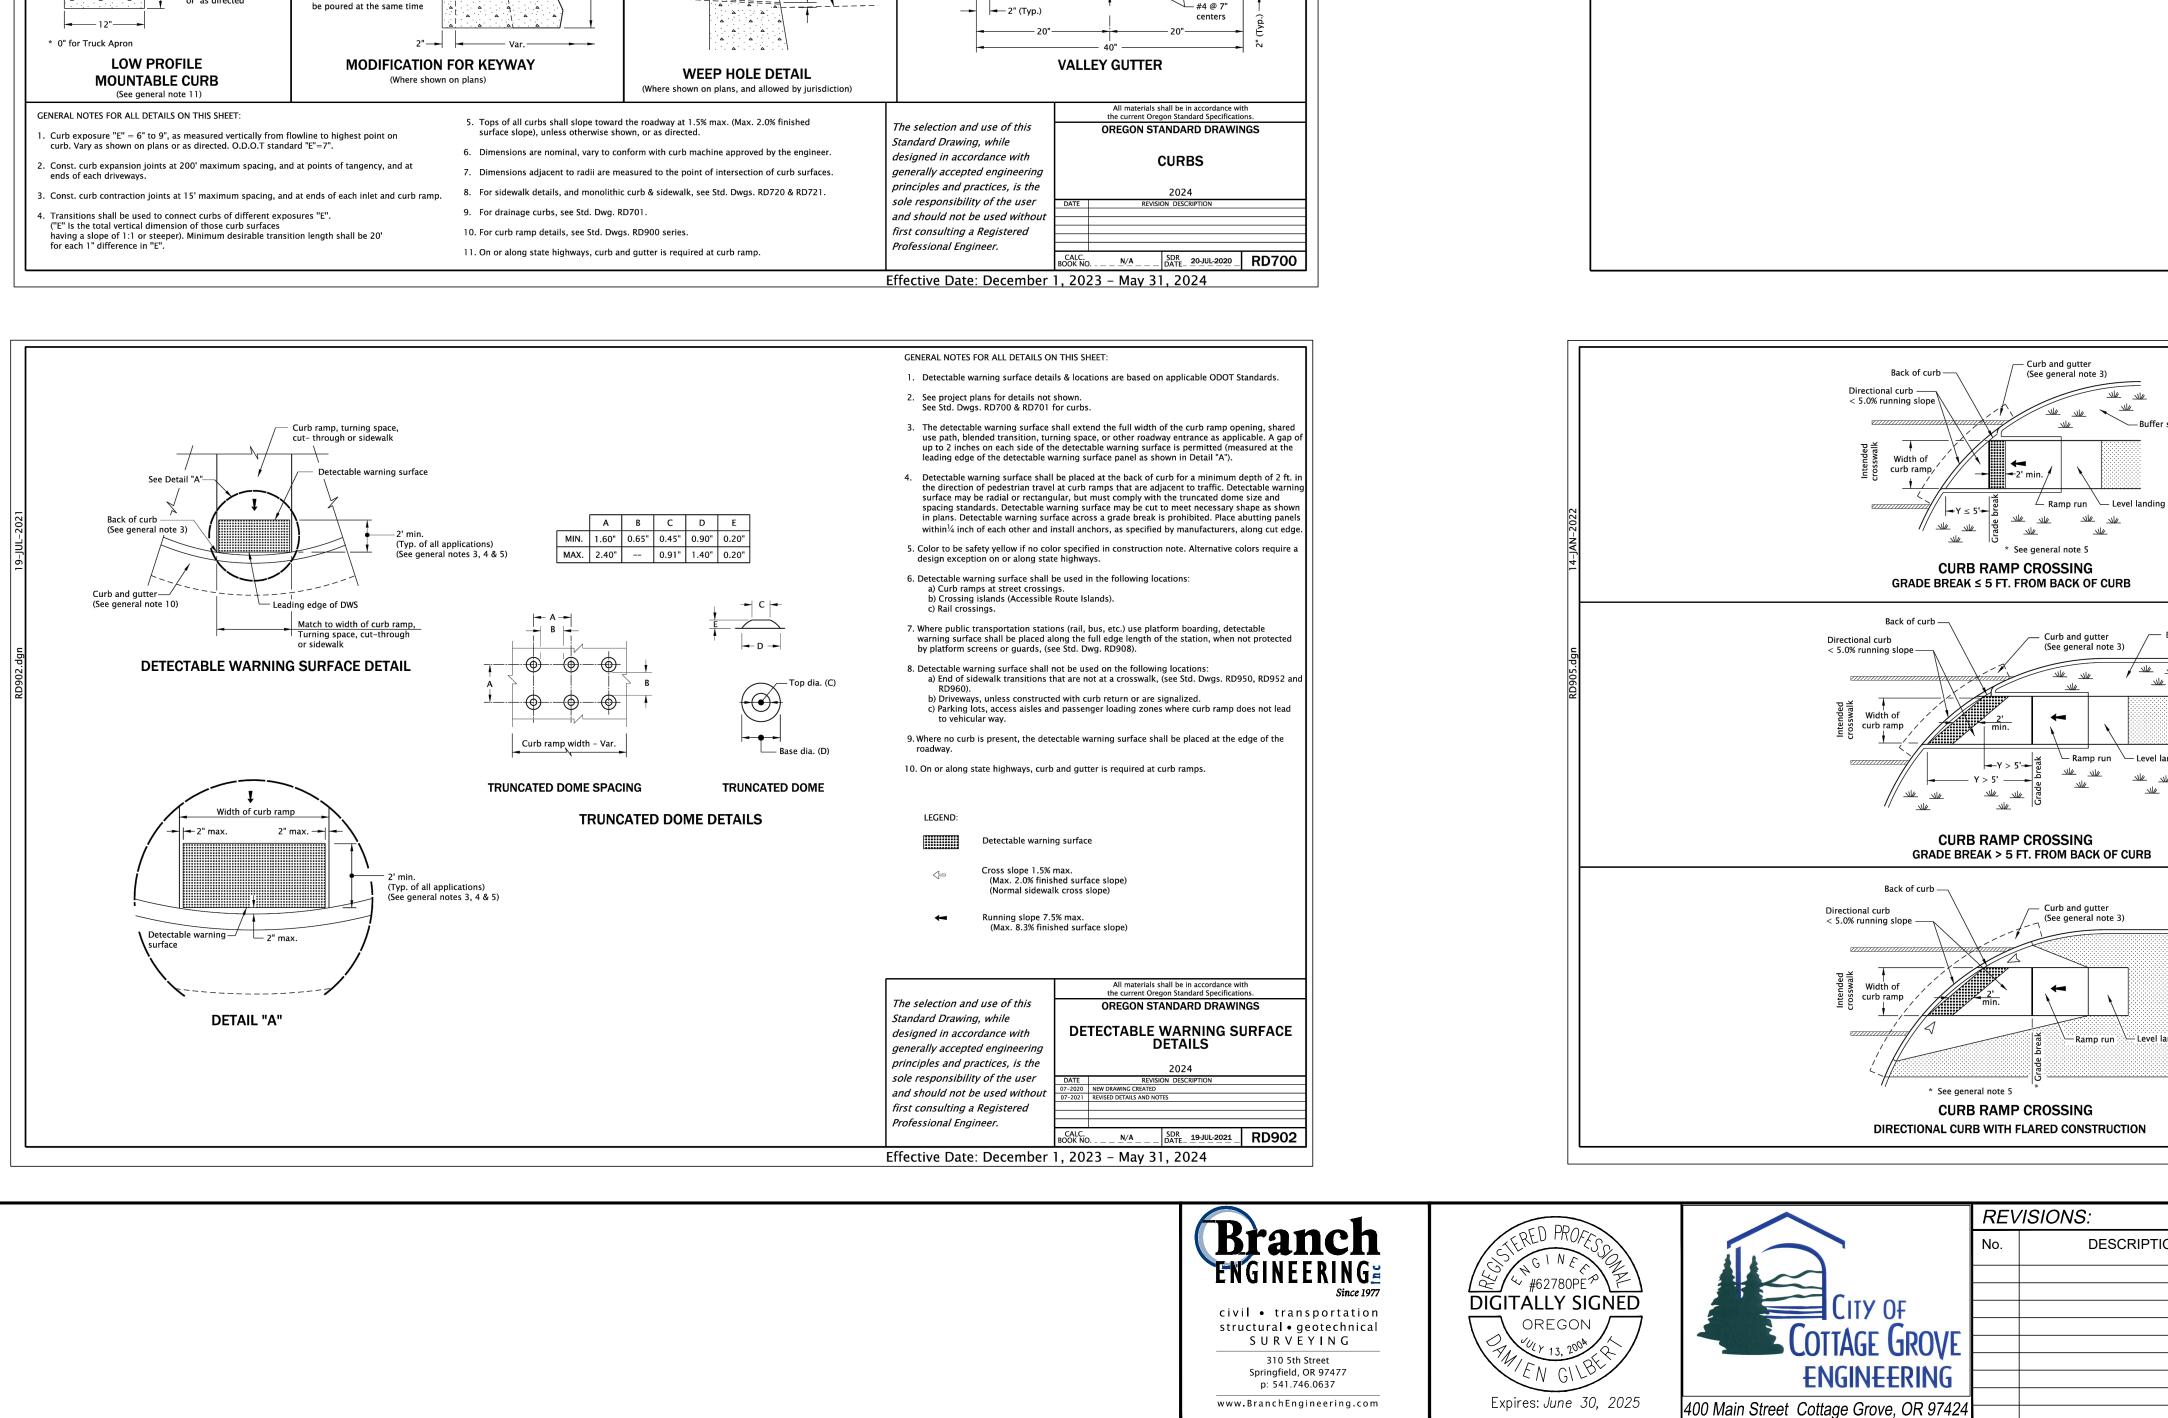

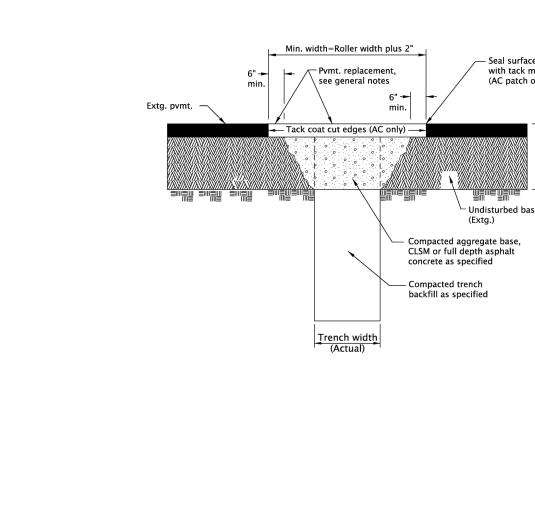

		first consulti. Professional	and be used without ing a Registered Engineer. CALC. BOOK NO Date: December 1, 2023 –	NOTES	2_ RD905	
ON	DATE		ROVE NSION			
		C	Sheet No. <b>C401</b>			
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	I		1		1	

	Standard Drawing, while designed in accordance with generally accepted engineering principles and practices, is the sole responsibility of the user and should not be used without first consulting a Registered Professional Engineer. Effective Date: December	STREET CUT           2024           DATE         REVISION DESCRIPTION           CALC         BOOK NO N/A BOR         SDR         20-JUL-2020         RD302           CALC         JUL-2020         RD302         T1, 2023 - May 31, 2024         RD304
strip (non-walkable)	<ol> <li>See project plans for details not sh See Std. Dwgs. RD700 &amp; RD701 for See Std. Dwg. RD902 for detectable</li> <li>On or along state highways, curb a</li> <li>Detectable warning surface placem</li> </ol>	& locations are based on applicable ODOT Standards. own. curbs. e warning surface installation details.
Buffer strip (non-walkable)	Sidewalk  Sidewalk  Center of the state of t	
nding	The selection and use of this Standard Drawing, while designed in accordance with generally accepted engineering principles and practices, is the sole responsibility of the user and should not be used without first consulting a Registered Professional Engineer. Effective Date: December	All materials shall be in accordance with the current Oregon Standard Specifications. OREGON STANDARD DRAWINGS DETECTABLE WARNING SURFACE PLACEMENT FOR DIRECTIONAL CURBS 2024 DATE REVISION DESCRIPTION 07-2020 NEW DRAWING CREATED 01-2022 REVISED NOTES REVISION DESCRIPTION 0-2022 REVISED NOTES 0-2022 NEW JEAN ON CREATED 0-2022 REVISED NOTES 0-2022 REVISED NOTES 0-2023 - May 31, 2024

GENERAL NOTES FOR ALL DETAILS ON THIS SHEET:

whichever is greater. Compact as specified.

The selection and use of this

All existing AC or PCC pavement shall be sawcut prior to repaving.

or to the thickness of removed pavement, whichever is greater.

2. Concrete pavement shall be replaced with concrete to a minimum thickness of 8"

All materials shall be in accordance with

OREGON STANDARD DRAWINGS

the current Oregon Standard Specificat


3. For joining new concrete to existing concrete, see contract plans for sepecific

4. Place AC mix minimum thkn. of 6" or the thkn. of the removed pavement,





- Seal surface over joint with tack material and sand

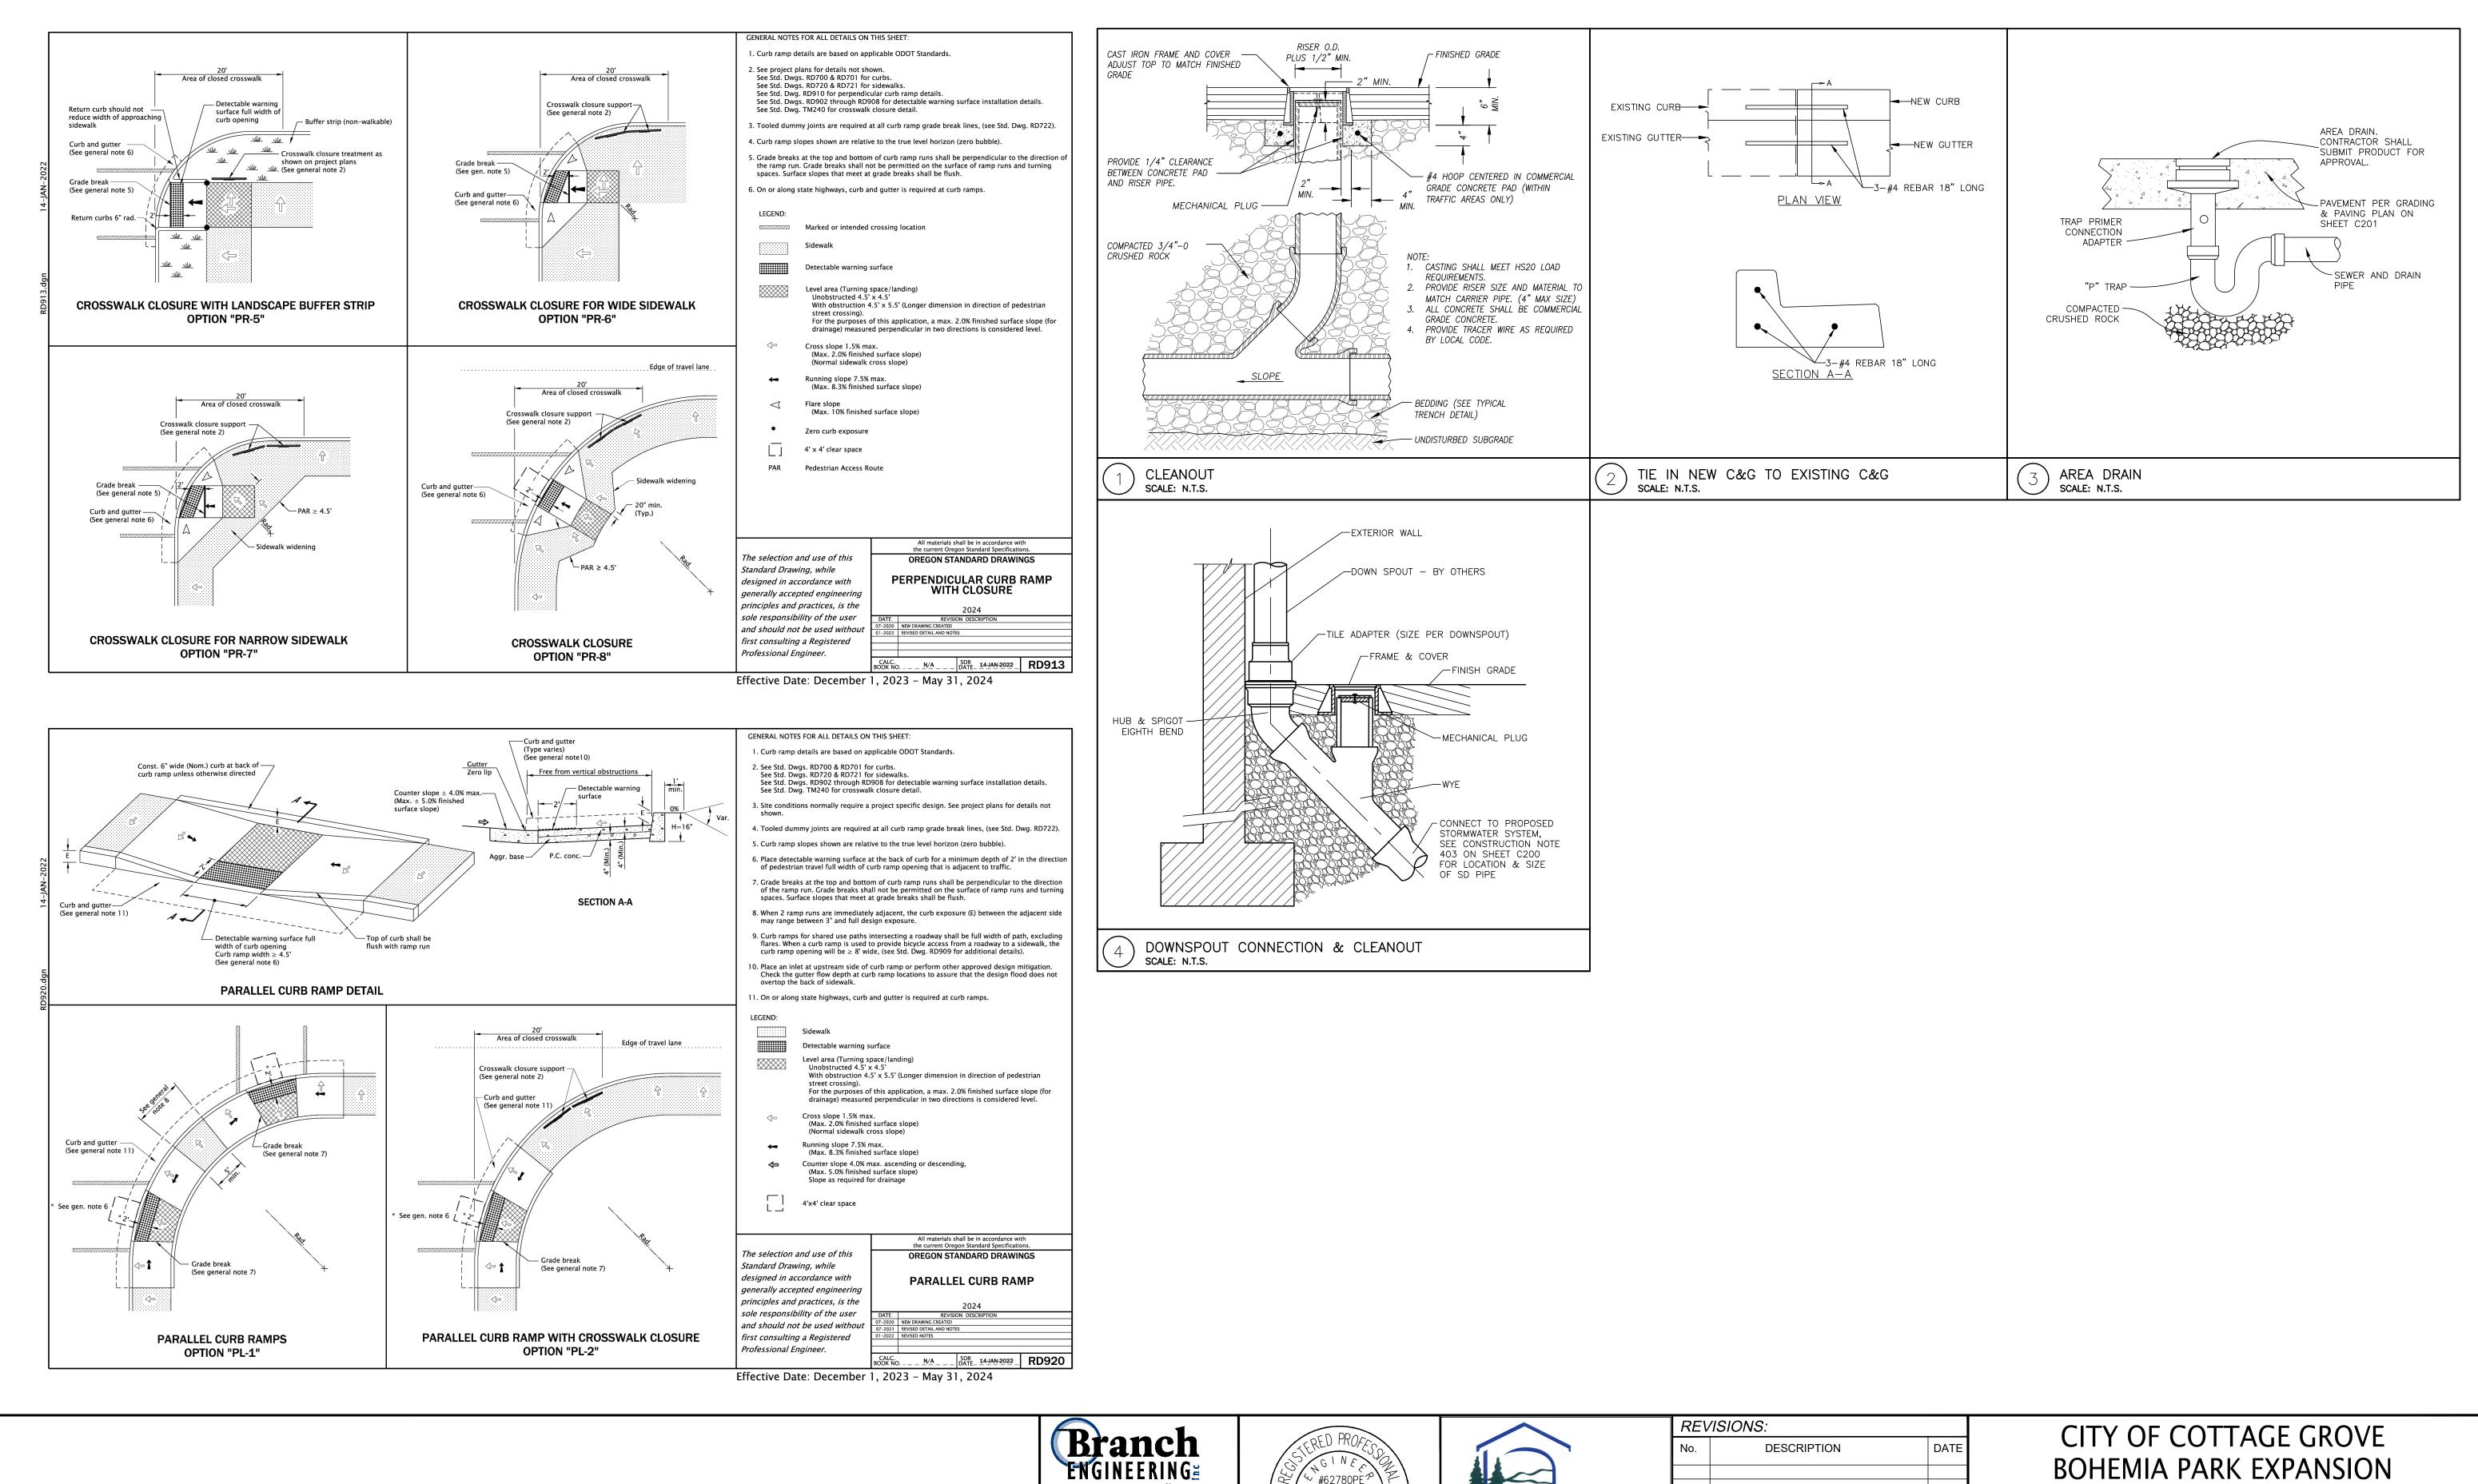

✓ / ✓ #62780PE<sup>∞</sup>

DIGITALLY SIGNED

OREGON

Expires: June 30, 2025

City Of

CottAge Grove

ENGINEERING

400 Main Street Cottage Grove, OR 97424

Since 197

civil • transportation


structural • geotechnical


SURVEYING 310 5th Street


Springfield, OR 97477 p: 541.746.0637


www.BranchEngineering.com


ON	DATE	<u> </u>	BOHEMIA PARK EXPANSION				
		CIVIL DETAILS			Sheet No. <b>C402</b>		
		DRAWN BY:	CHECKED BY:	DATE:			
		ZZ	DG	04/10/24	JOB No.	22-001K	

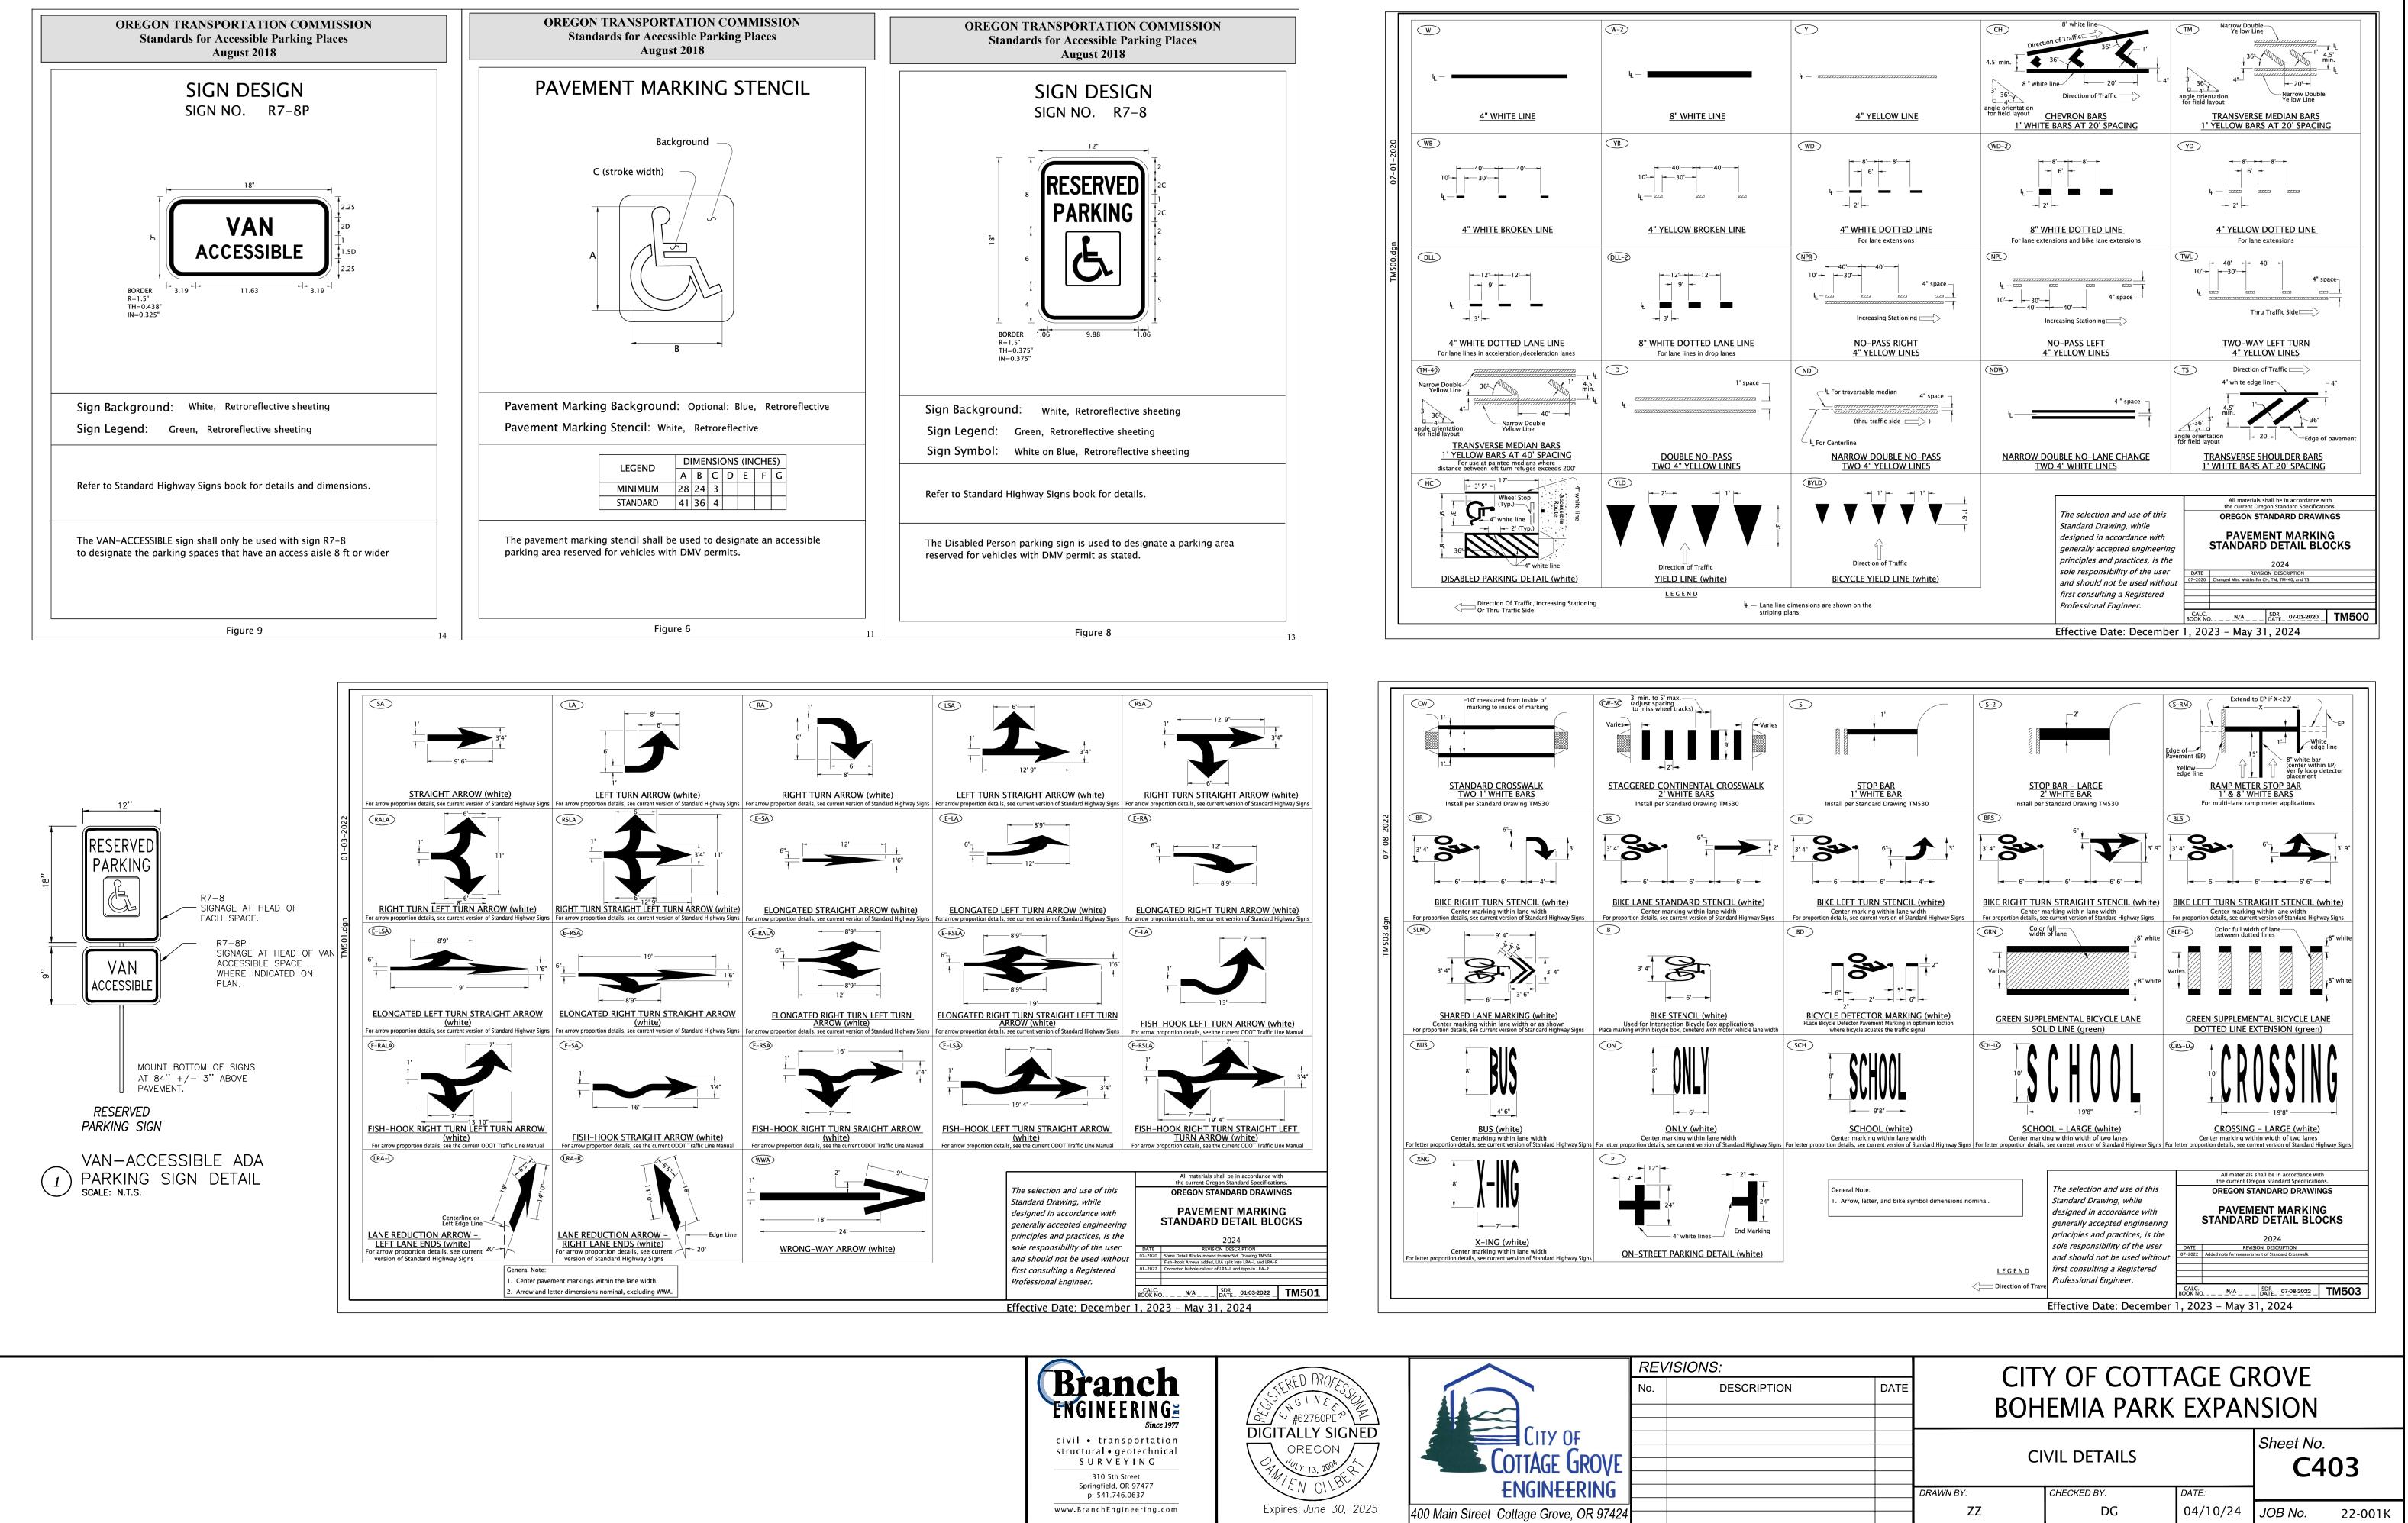

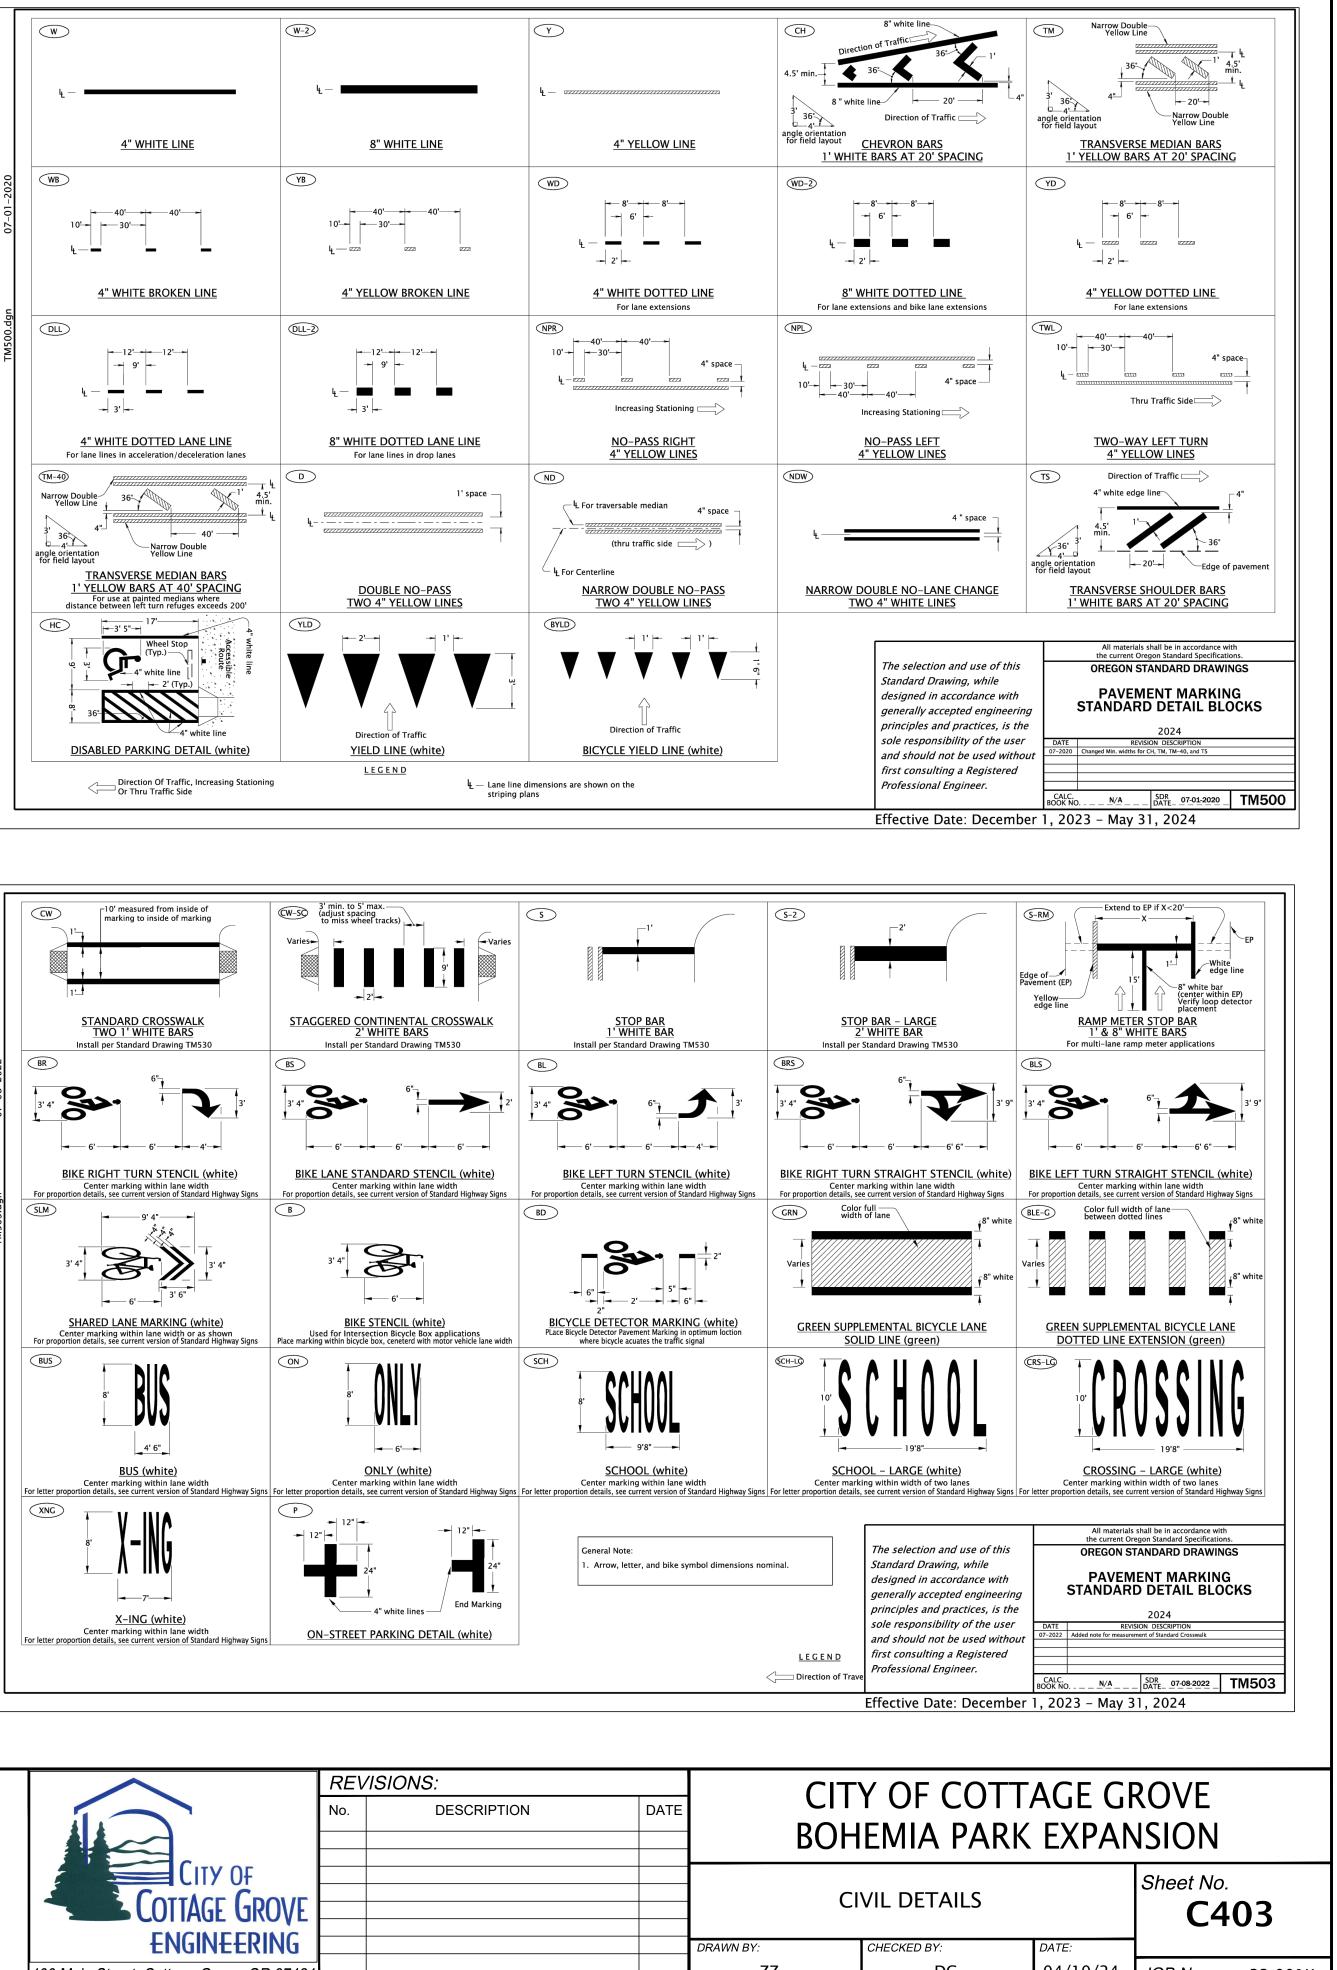

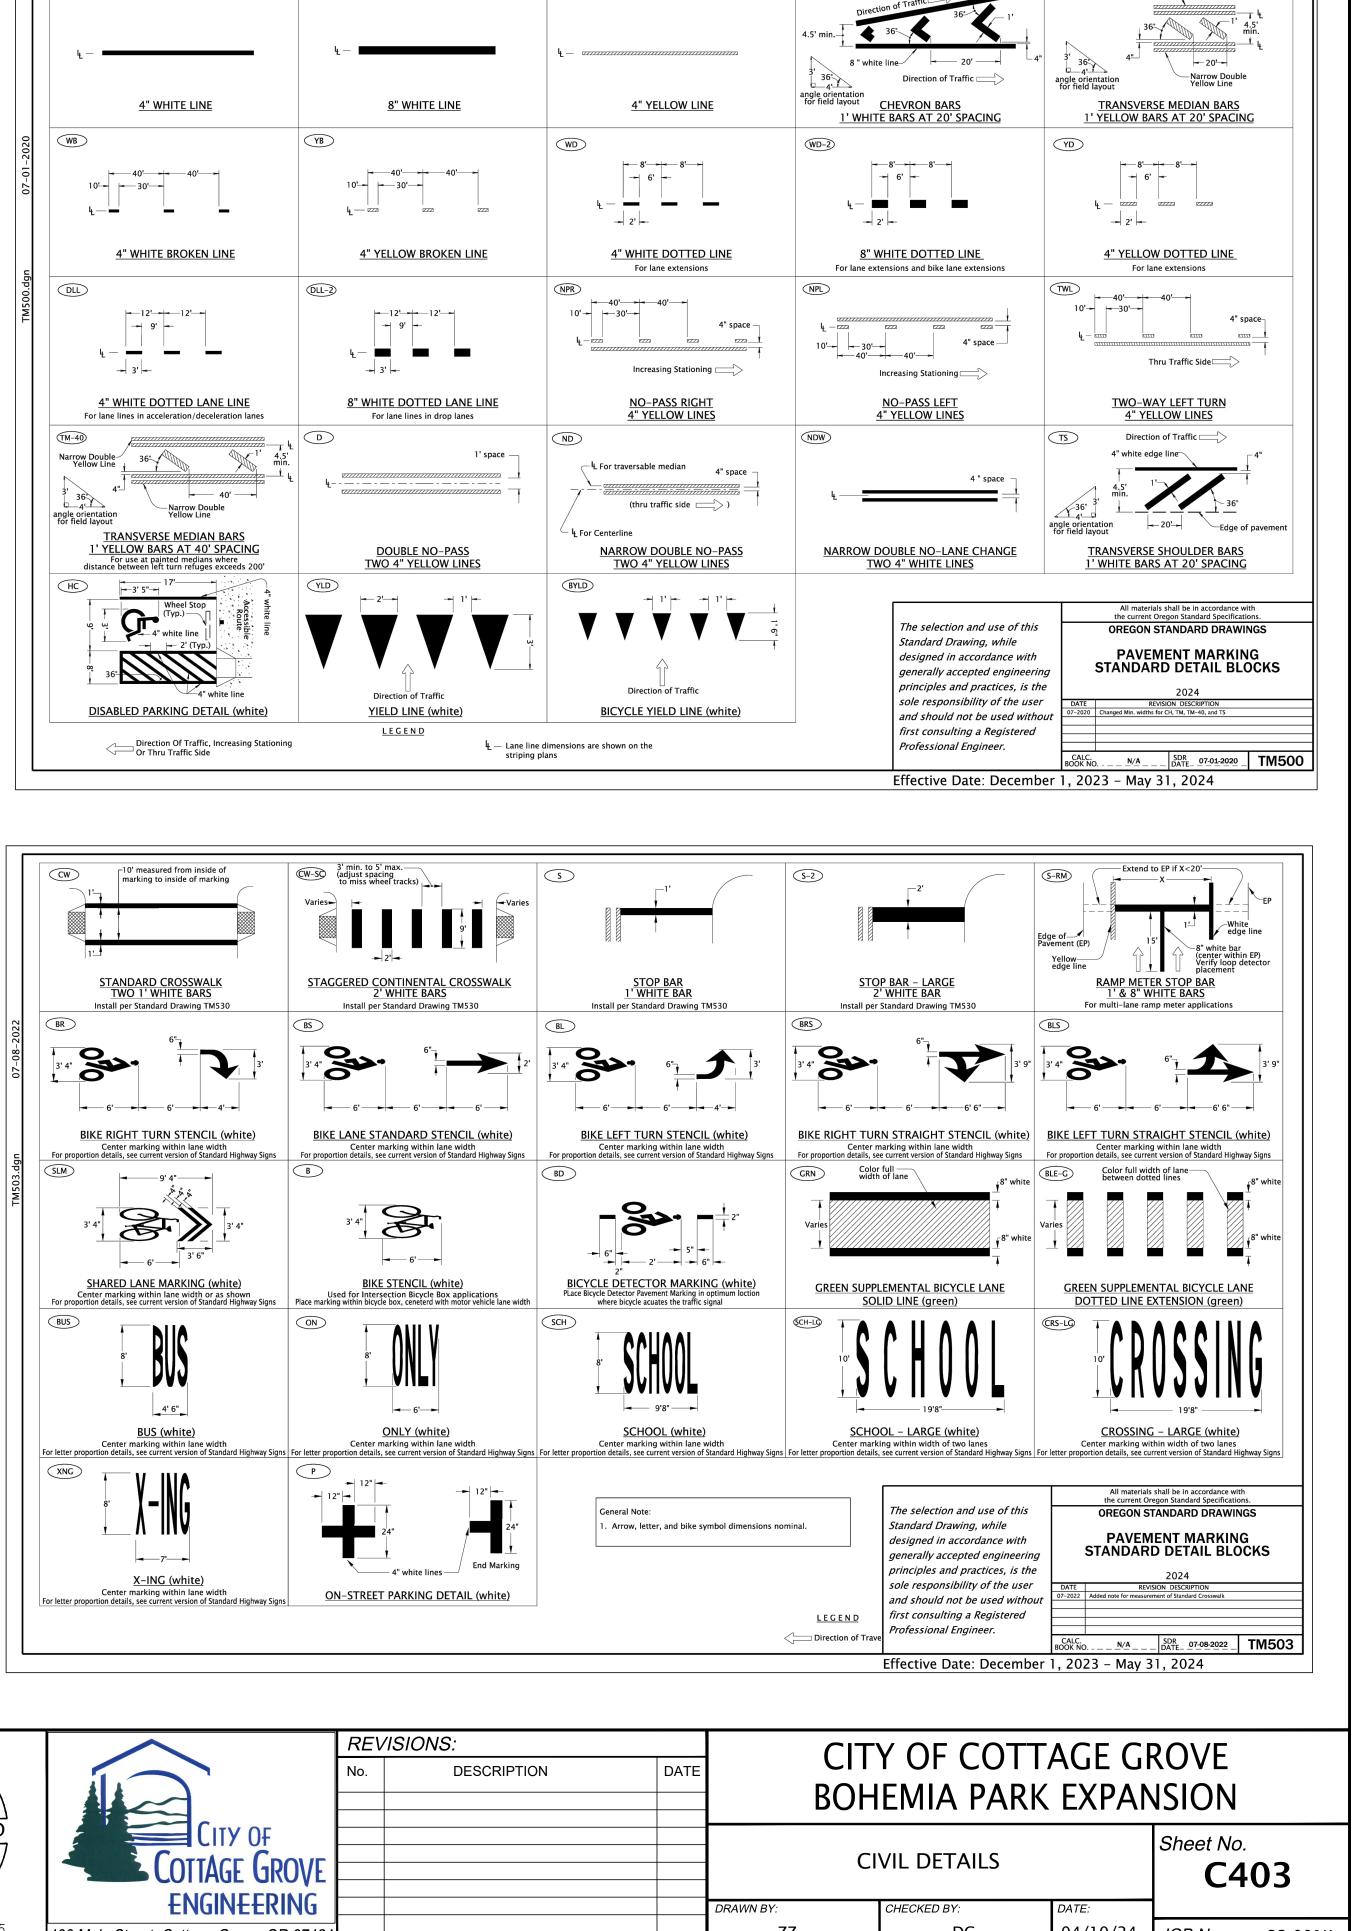

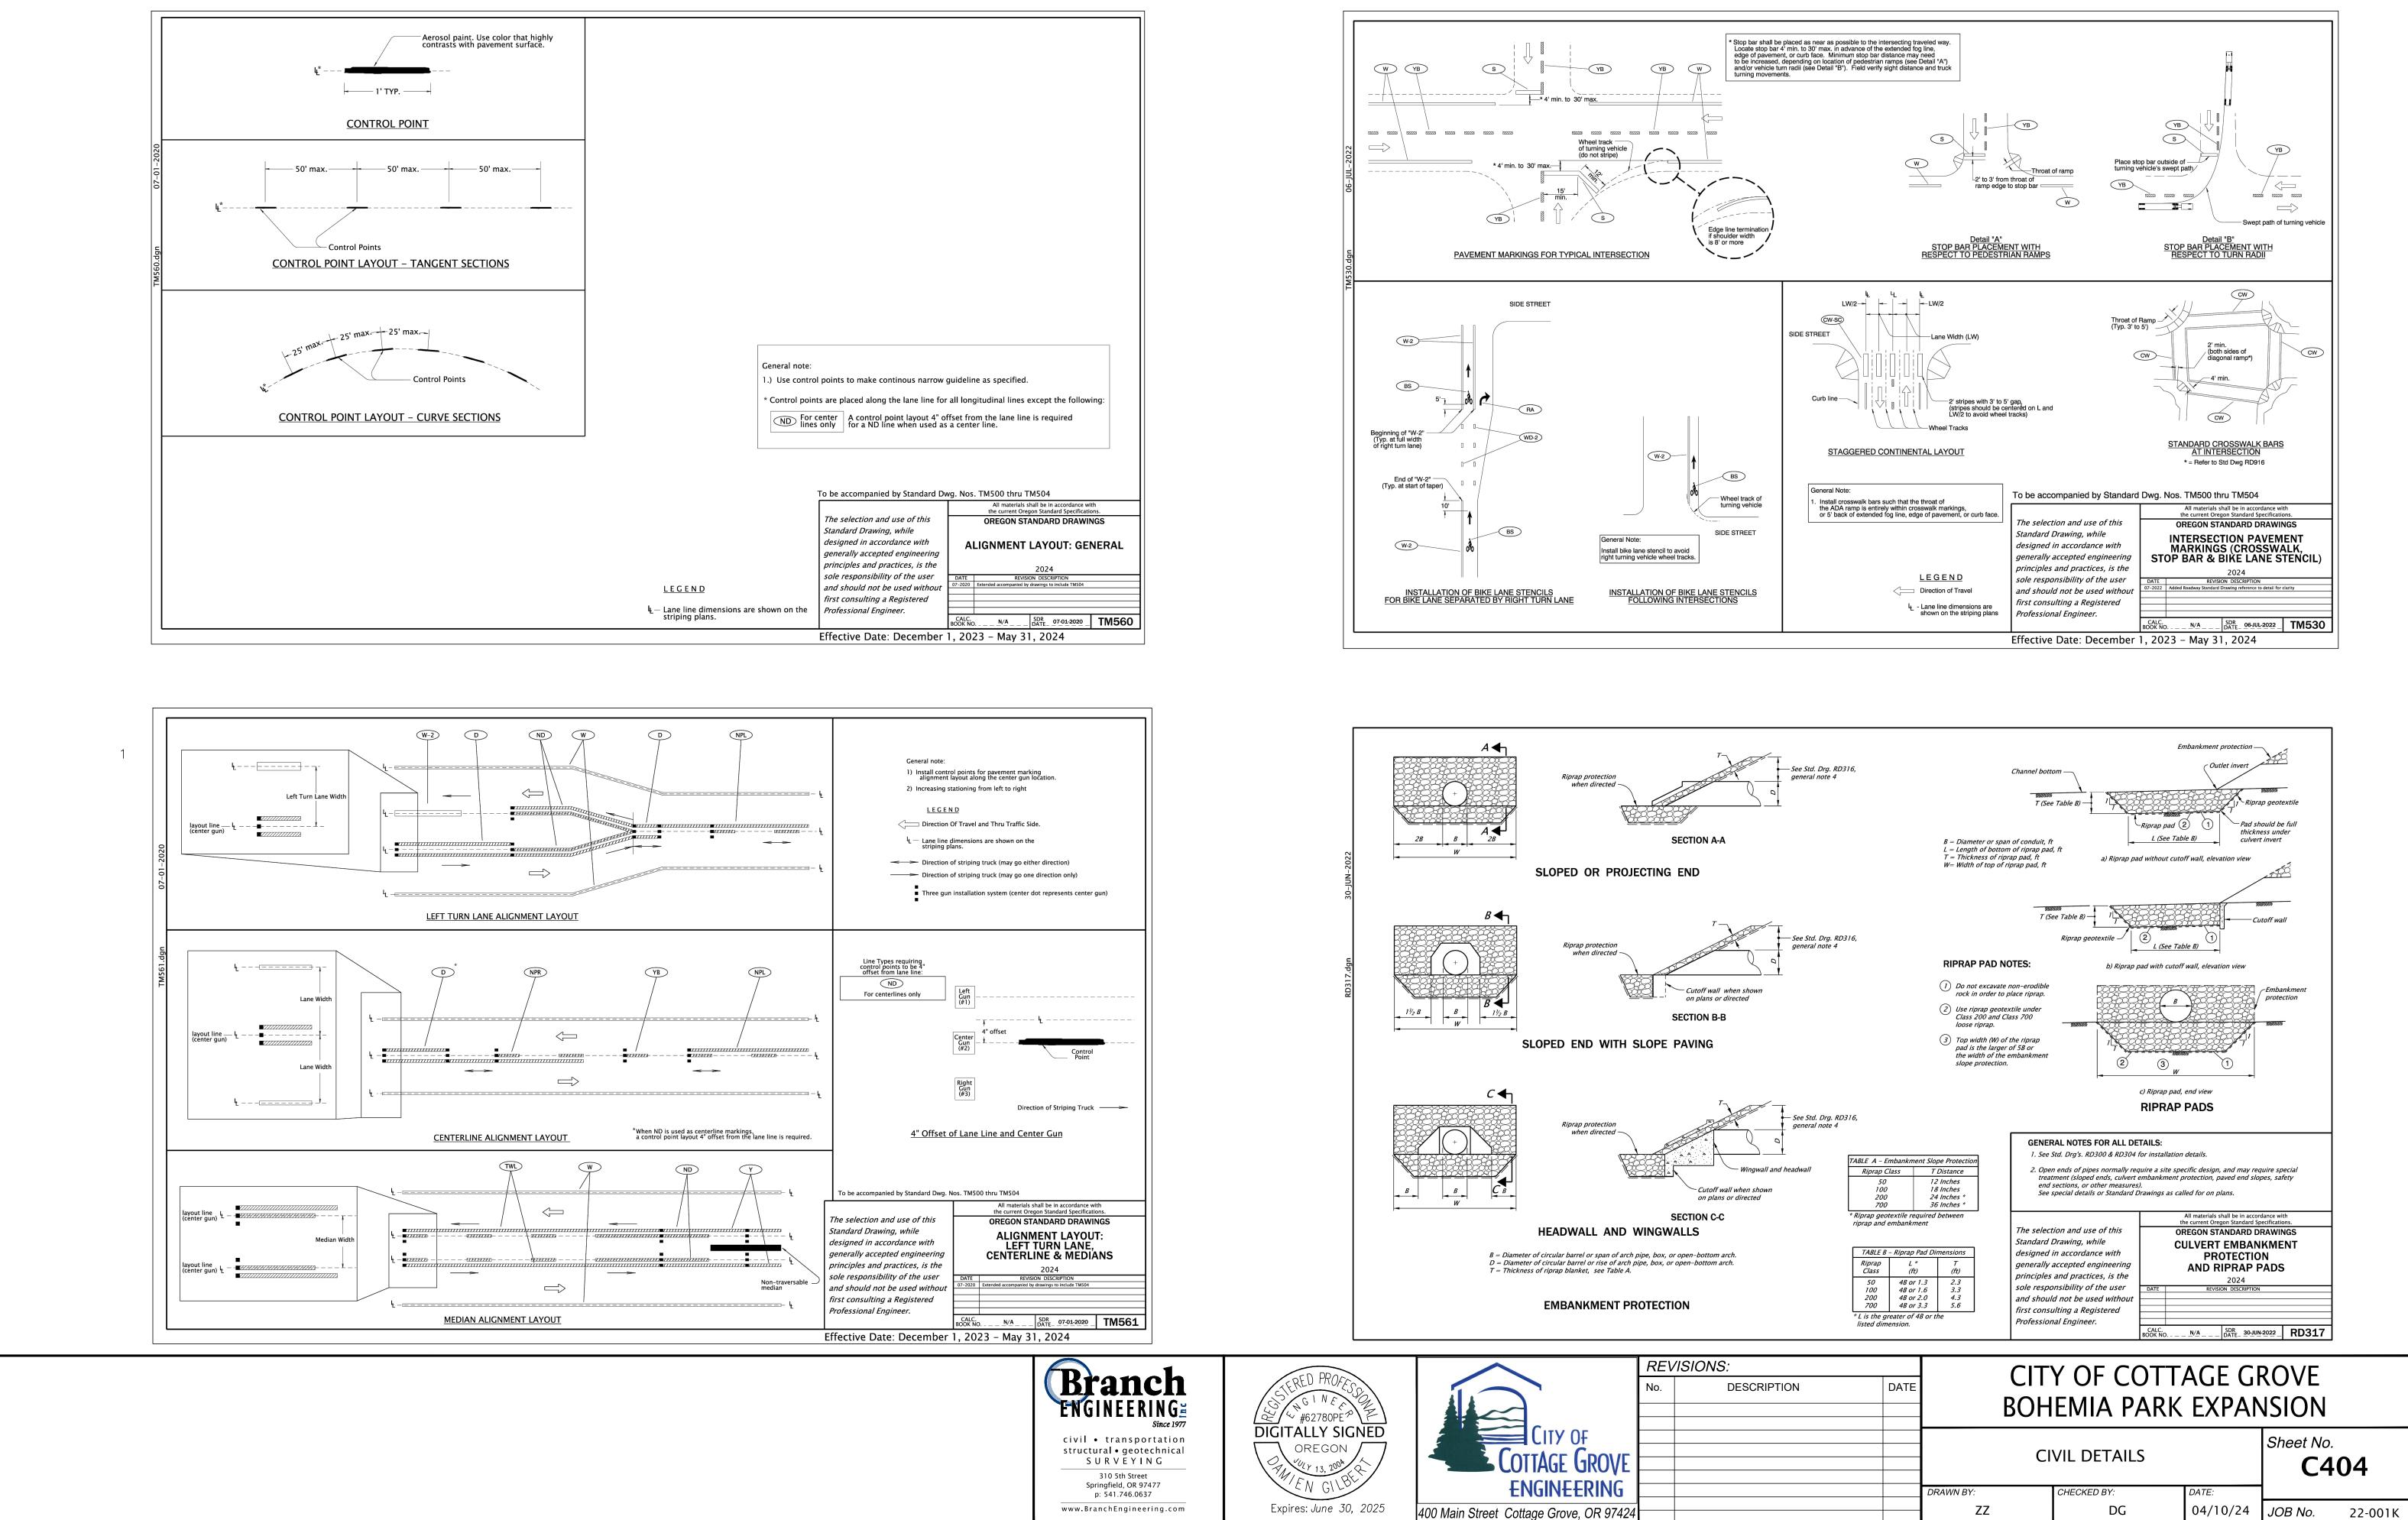

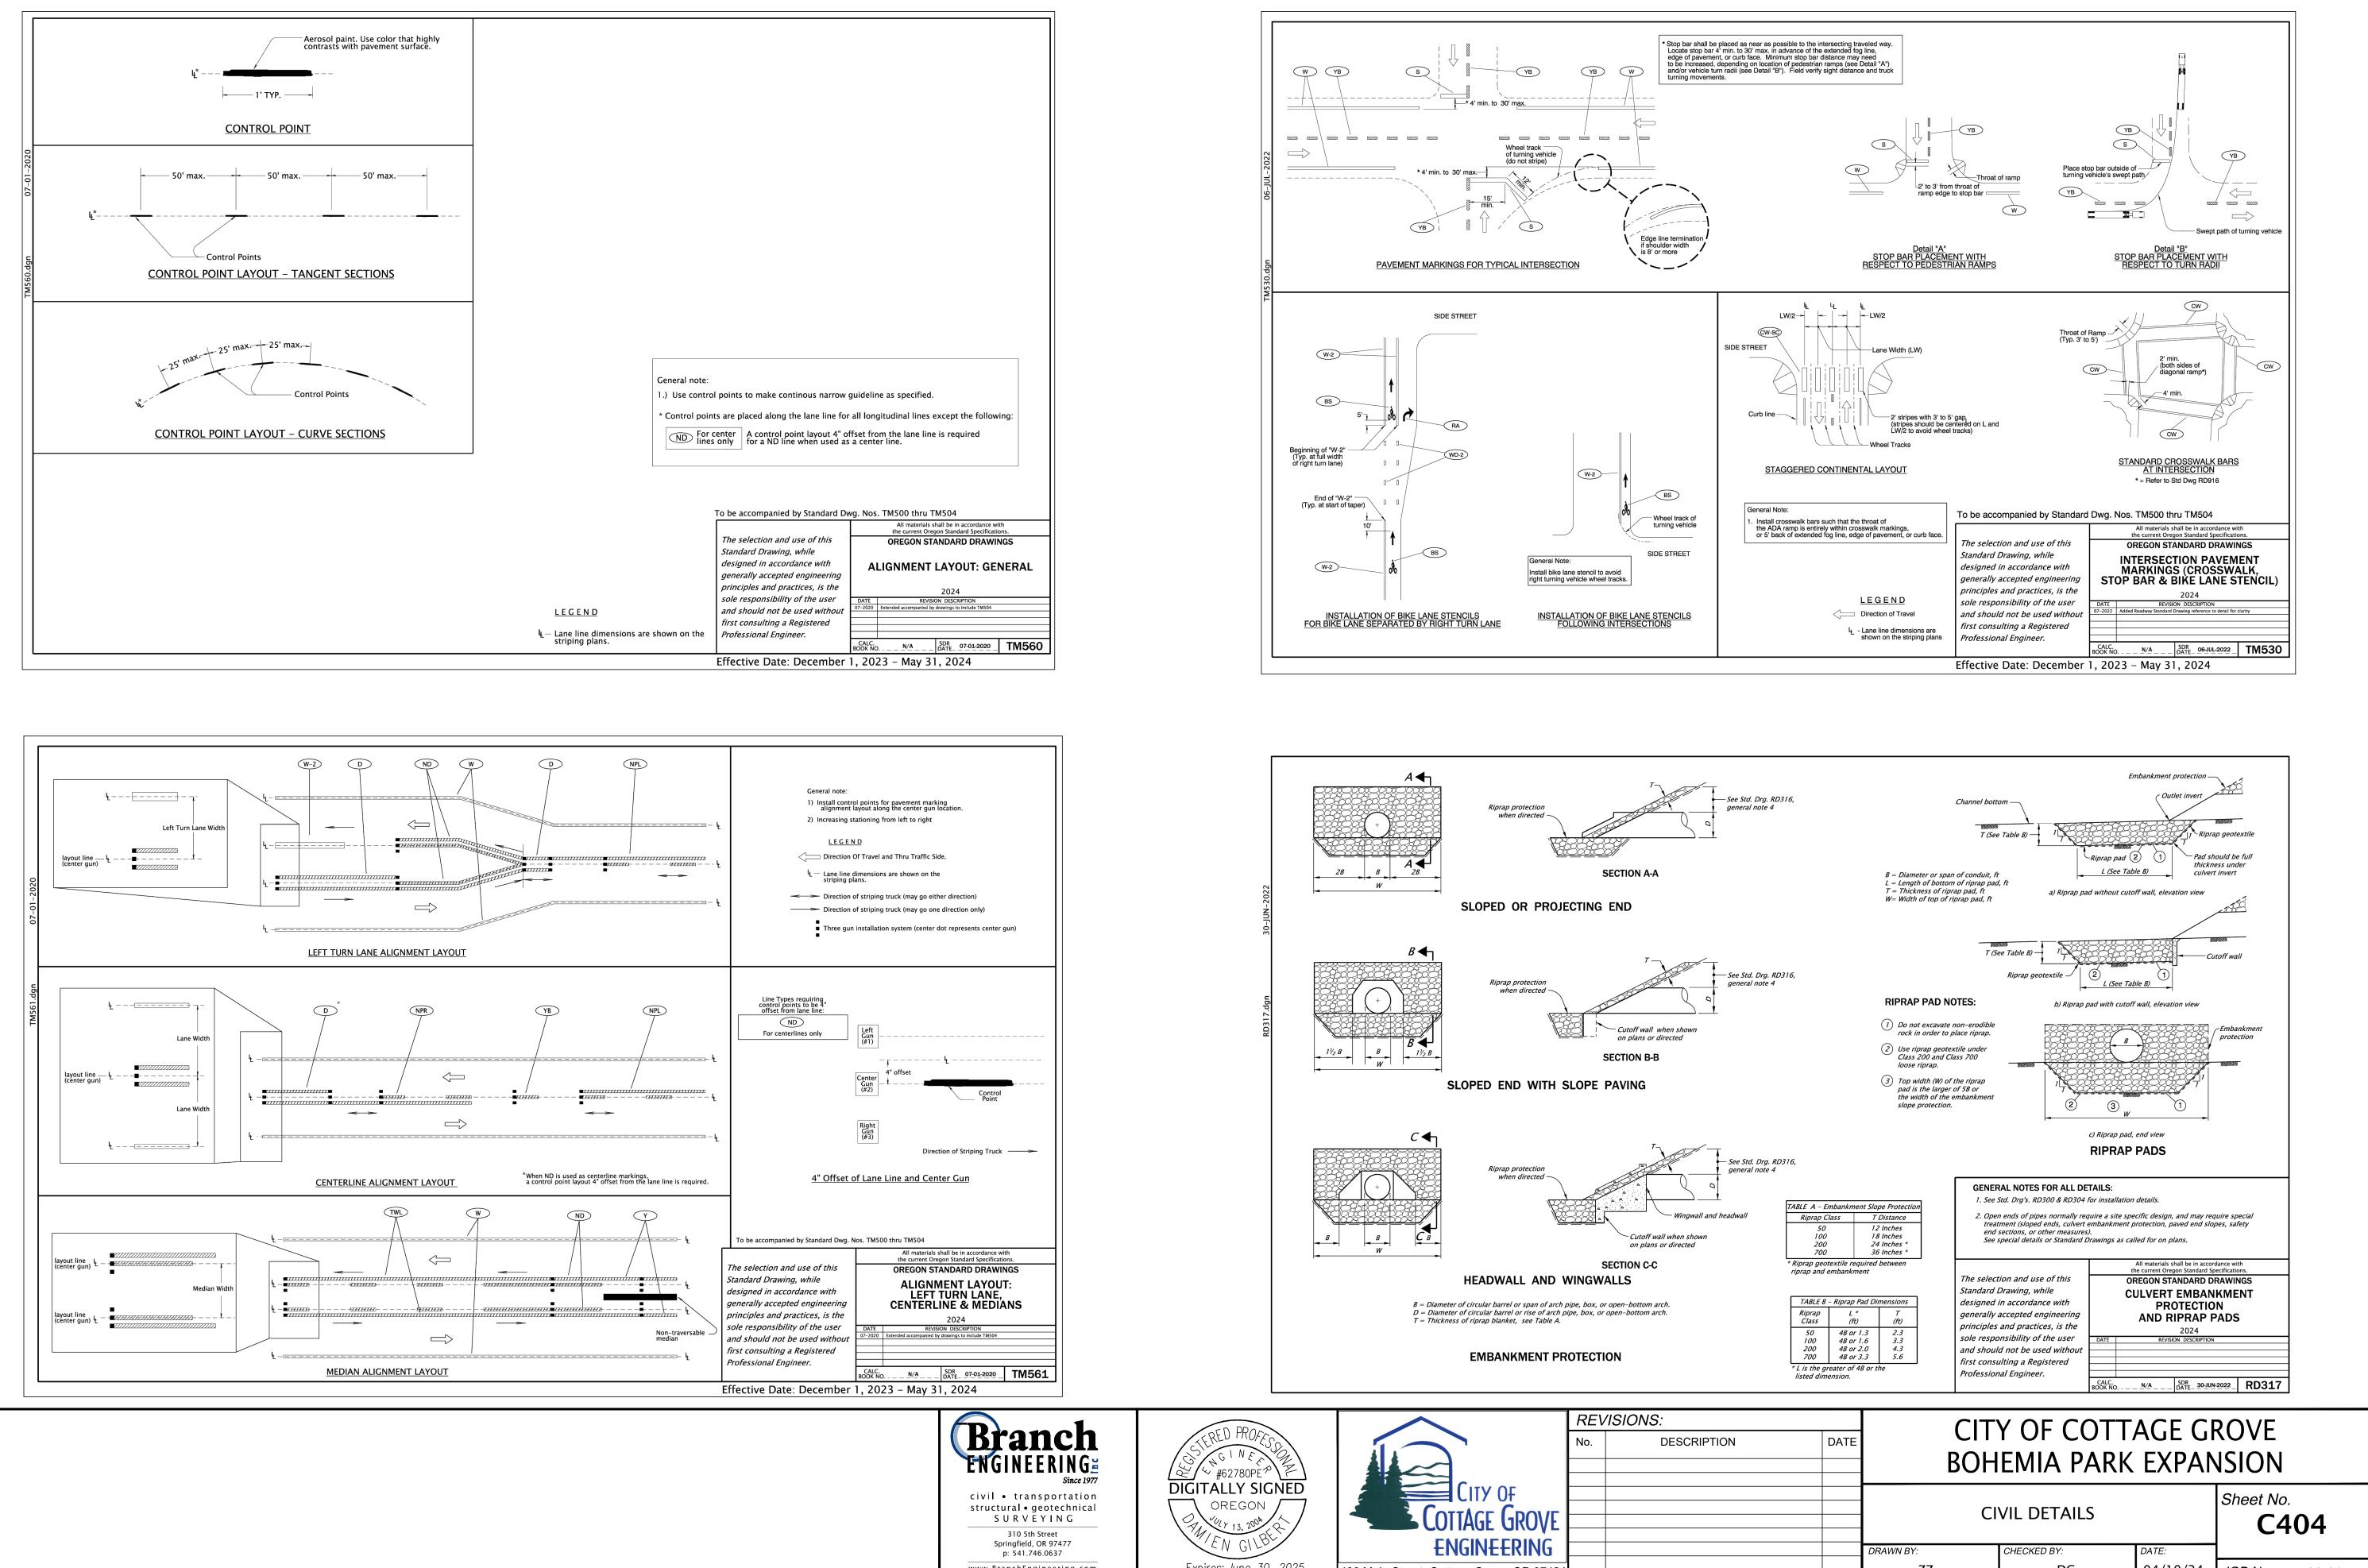

### SITE INFORMATION

TYPE	OF	DEVELOPMENT:	PUBLIC	IMPROVEMENT

- 1. CONSTRUCTION ACTIVITY WILL CONSIST OF: a. NEW PAVING
  - b. UTILITY INSTALLATION
  - c. LIGHTING INSTALLATION
  - d. LANDSCAPE IMPROVEMENTS
- 2. PROJECT TIMELINE: CLEARING: SPRING, 2024 MASS GRADING: SPRING/SUMMER, 2024 UTILITY CONSTRUCTION: SUMMER, 2024 VERTICAL CONSTRUCTION: N/A FINAL STABILIZATION: SUMMER/FALL 2024
- 3. PROJECT HOURS: MONDAY-SATURDAY, 7AM-7PM
- 4. PROJECT SITE AREAS:
- DISTURBED AREA:

- 32 COBURG-URBAN LAND COMPLEX.
- 6. EXCAVATION: CUT: 60 CY

5. ONSITE SOIL TYPES:

- FILL: 580 CY NET: 520 CY FILL
- CUT AND FILL VOLUMES ARE FROM THE EXISTING SURFACE TO FINISHED GRADE SURFACE.

INSPECTION SCHEDULE

	SITE CONDITION	MINIMUM FREQUENCY
1.	ACTIVE PERIOD	ON INITIAL DATE THAT LAND DISTURBANCE ACTIVITIES COMMENCE. WITHIN 24 HOURS OF ANY STORM EVENT, INCLUDING RUNOFF FROM SNOW MELT, THAT RESULTS IN DISCHARGE FROM THE SITE. AT LEAST ONCE EVERY 14 DAYS, REGARDLESS OF WETHER STORMWATER RUNOFF IS OCCURRING.
2.	INACTIVE PERIODS GREATER THAN FOURTEEN (14) CONSECUTIVE CALENDAR DAYS	THE INSPECTOR MAY REDUCE THE FREQUENCY OF INSPECTIONS IN ANY ARE OF THE SITE WHERE THE STABILIZATION STEPS IN SECTION 2.2.20 HAVE BEEN COMPLETED TO TWICE PER MONTH FOR THE FIRST MONTH, NO LESSS THAN 14 CALENDAR DAYS APART, THEN ONCE PER MONTH.
3.	PERIODS DURING WHICH THE SITE IS INACCESSIBLE DUE TO INCLEMENT WEATHER	IF SAFE, ACCESSIBLE AND PRACTICAL, INSPECTIONS MUST OCCUR DAILY AT A RELEVANT DISCHARGE POINT OR DOWNSTREAM LOCATION OF THE RECEIVING WATERBODY.
4.	PERIODS DURING WHICH CONSTRUCTION ACTIVITIES ARE SUSPENDED AND RUNOFF IS UNLIKELY DUE TO FROZEN CONDITIONS.	VISUAL MONITORING INSPECTIONS MAYBE TEMPORARILY SUSPENDED. IMMEDIATELY RESUME MONITORING UPON THAWING, OR WHEN WEATHER CONDITIONS MAKE DISCHARGES LIKELY.
5.	PERIODS DURING WHICH CONSTRUCTION ACTIVITIES ARE CONDUCTED AND RUNOFF IS UNLIKELY DURING FROZEN CONDITIONS.	VISUAL MONITORING INSPECTIONS MAYBE REDUCED TO ONCE A MONTH. IMMEDIATELY RESUME MONITORING UPON THAWING, OR WHEN WEATHER CONDITIONS MAKE DISCHARGES LIKELY.

<1.0 ACRE

# EROSION CONTROL CONSTRUCTION NOTES

- 1. OWNER OR DESIGNATED PERSON SHALL BE RESPONSIBLE FOR PROPER INSTALLATION AND MAINTENANCE OF ALL EROSION AND SEDIMENT CONTROL (ESC) MEASURES, IN ACCORDANCE WITH LOCAL, STATE, AND FEDERAL REGULATIONS.
- THE IMPLEMENTATION OF THESE ESC PLANS AND CONSTRUCTION, MAINTENANCE, REPLACEMENT, AND UPGRADING OF THESE ESC 2. FACILITIES IS THE RESPONSIBILITY OF THE CONTRACTOR UNTIL ALL CONSTRUCTION IS COMPLETED AND APPROVED BY THE LOCAL JURISDICTION, AND VEGETATION/LANDSCAPING IS ESTABLISHED. THE DEVELOPER SHALL BE RESPONSIBLE FOR MAINTENANCE AFTER THE PROJECT IS APPROVED.
- 3. THE BOUNDARIES OF THE CLEARING LIMITS SHOWN ON THIS PLAN SHALL BE CLEARLY MARKED IN THE FIELD PRIOR TO CONSTRUCTION. DURING THE CONSTRUCTION PERIOD, NO DISTURBANCE BEYOND THE CLEARING LIMITS SHALL BE PERMITTED. THE MARKINGS SHALL BE MAINTAINED BY THE APPLICANT/CONTRACTOR FOR THE DURATION OF CONSTRUCTION.
- 4. THE ESC FACILITIES SHOWN ON THIS PLAN MUST BE CONSTRUCTED IN CONJUNCTION WITH ALL CLEARING AND GRADING ACTIVITIES, AND IN SUCH A MANNER AS TO INSURE THAT SEDIMENT AND SEDIMENT LADEN WATER DOES NOT ENTER THE DRAINAGE SYSTEM, ROADWAYS. OR VIOLATE APPLICABLE WATER STANDARDS.
- 5. THE ESC FACILITIES SHOWN ON THIS PLAN ARE MINIMUM REQUIREMENTS FOR ANTICIPATED SITE CONDITIONS. DURING CONSTRUCTION PERIOD, THESE ESC FACILITIES SHALL BE UPGRADED AS NEEDED FOR UNEXPECTED STORM EVENTS AND TO ENSURE THAT SEDIMENT AND SEDIMENT LADEN WATER DOES NOT LEAVE THE SITE.
- THE ESC FACILITIES SHALL BE INSPECTED DAILY BY THE APPLICANT/CONTRACTOR AND MAINTAINED AS NECESSARY TO ENSURE 6. THEIR CONTINUED FUNCTIONING.
- 7. AT NO TIME SHALL SEDIMENT BE ALLOWED TO ACCUMULATE MORE THEN 1/3 THE BARRIER HEIGHT. ALL CATCH BASINS AND CONVEYANCE LINES SHALL BE CLEANED PRIOR TO PAVING. THE CLEANING OPERATIONS SHALL NOT FLUSH SEDIMENT LADEN WATER INTO THE DOWNSTREAM SYSTEM.
- 8. STABILIZED GRAVEL ENTRANCES SHALL BE INSTALLED AT THE BEGINNING OF CONSTRUCTION AND MAINTAINED FOR THE DURATION OF THE PROJECT. ADDITIONAL MEASURES MAY BE REQUIRED TO INSURE THAT ALL PAVED AREAS ARE KEPT CLEAN FOR THE DURATION OF THE PROJECT.
- 9. STORM DRAINS INLETS, BASINS, AND AREA DRAINS SHALL BE PROTECTED UNTIL PAVEMENT SURFACES ARE COMPLETED AND/OR VEGETATION IS RE-ESTABLISHED.
- 10. PAVEMENT SURFACES AND VEGETATION ARE TO BE PLACED AS RAPIDLY AS POSSIBLE.
- 11. SEEDING SHALL BE PERFORMED NO LATER THAN SEPTEMBER 1 FOR EACH PHASE OF CONSTRUCTION.
- 12. IF THERE ARE EXPOSED SOILS OR SOILS NOT FULLY ESTABLISHED FROM OCTOBER 1ST THROUGH APRIL 30TH, THE WET WEATHER EROSION PREVENTION MEASURES WILL BE IN EFFECT. SEE EROSION PREVENTION AND SEDIMENT CONTROL BMP'S FOR REQUIREMENTS.
- 13. THE DEVELOPER SHALL REMOVE ESC MEASURES WHEN VEGETATION IS FULLY ESTABLISHED.

# **BOHEMIA PARK EXPANSION** FOR THE CITY OF COTTAGE GROVE 101 SOUTH 10TH STREET

COTTAGE GROVE, OREGON

# WET WEATHER PERMIT CONDITIONS

- 1. WET WEATHER EROSION PREVENTION MEASURES WILL BE IN EFFECT FROM OCTOBER 1 THROUGH APRIL 30.
- 2. SOIL EXPOSED FOR MORE THAN 2 DAYS SHALL BE COVERED WITH PLASTIC SHEETING, MATTING, OR A 2-INCH LAYER OF MULCH, BARK, WOOD CHIPS, SAWDUST, OR STRAW TO MINIMIZE EROSION POTENTIAL
- 3. EXPOSED SOILS SHALL BE SEEDED NO LATER THAN SEPTEMBER 1ST TO ALLOW TIME FOR PROPER GERMINATION AND GROWTH BEFORE THE WET WEATHER SEASON.

### FINAL STABALIZATION


FINAL STABILIZATION OF ALL DISTURBED AREAS TO BE ADDRESSED BY THE CONTRACTOR. SEE RECOMMENDED BMP MATRIX ON THIS SHEET.

### RATIONAL STATEMENT

A COMPREHENSIVE LIST OF AVAILABLE BEST MANAGEMENT PRACTICES (BMP) OPTIONS BASED ON DEQ'S GUIDANCE MANUAL HAS BEEN REVIEWED TO COMPLETE THIS EROSION AND SEDIMENT CONTROL PLAN. SOME OF THE ABOVE LISTED BMPs WERE NOT CHOSEN BECAUSE THEY WERE DETERMINED TO NOT EFFECTIVELY MANAGE EROSION PREVENTION AND SEDIMENT CONTROL FOR THIS PROJECT BASED ON SPECIFIC SITE CONDITIONS INCLUDING SOIL CONDITIONS TOPOGRAPHIC CONSTRAINTS, ACCESSIBILITY TO THE SITE, AND OTHER RELATED CONDITIONS. AS THE PROJECT PROGRESSES AND THERE IS A NEED TO REVISE THE ESC PLAN. AN ACTION PLAN WILL BE SUBMITTED

## BMP MATRIX FOR CONSTRUCTION PHASE

BMP	CLEARING/ DEMO	MASS GRADING/ UTILITY CONSTRUCTION		FINAL STABILIZATION
BIOBAGS	X	Х	Х	Х
BIOSWALES				
CHECK DAMS				
COMPOST BERM				Х
COMPOST BLANKETS				
COMPOST SOCKS				
CONCRETE TRUCK WASHOUT			X	
CONSTRUCTION ENTRANCE	Х	Х	Х	Х
DEWATERING (TREATMENT LOCATION, SCHEMATIC & SAMPLING PLAN REQUIRED)				
DRAINAGE SWALES				
EARTH DIKES (STABILIZED)				
ENERGY DISSIPATERS				
EROSION CONTROL BLANKETS AND MATS (COIR MAT)	Х	Х	Х	
HYDROSEEDING				Х
INLET PROTECTION	X	Х	Х	Х
MULCHES (SPECIFY TYPE)				
MYCORRHIZAE/BIOFERTILIZERS				Х
NATURAL BUFFER ZONES				
ORANGE FENCING (PROTECTING SENSITIVE/PRESERVED AREAS)				
OUTLET PROTECTION				
PERMANENT SEEDING AND PLANTING				Х
PIPE SLOPE DRAINS				
PLASTIC SHEETING		Х	Х	
PRESERVE EXISTING VEGETATION		Х	Х	
SEDIMENT FENCE	Х	Х	Х	Х
SEDIMENT BARRIER				
SEDIMENT TRAP				
SODDING				
SOIL TRACKIFIERS				
STORM DRAIN INLET PROTECTION	X	Х	Х	Х
STRAW WATTLES (OR OTHER MATERIALS)				
TEMPORARY DIVERSION DIKES				
TEMPORARY OR PERMANENT SEDIMENTATION BASINS				
TEMPORARY SEEDING AND PLANTING				
TREATMENT SYSTEM (OPERATION & MAINTENANCE PLAN REQUIRED)				
UNPAVED ROADS GRAVELED OR OTHER BMP ON THE ROAD				
VEGETATIVE BUFFER STRIPS				

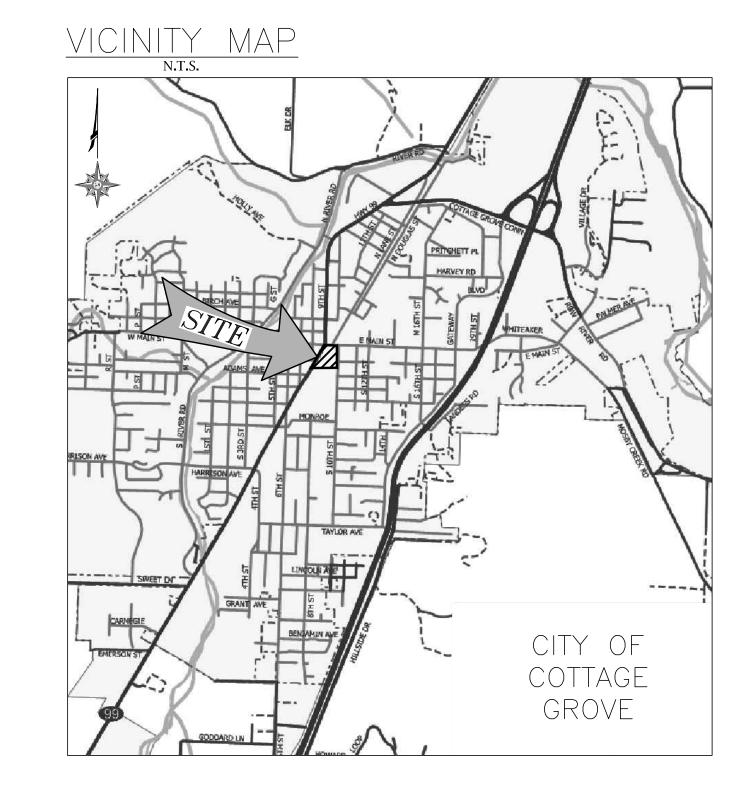


# ENGINEERED FILL

# OWNER/APPLICANT

CITY OF COTTAGE GROVE 400 E MAIN STREET COTTAGE GROVE, OREGON 97424 PHONE: (541) 942-3349 EMAIL: pwdirector@cottagegrove.org

### GEOTECHNICAL ENGINEER

BRANCH ENGINEERING, INC. CONTACT: RON DERRICK, PE, GE 310 5TH STREET SPRINGFIELD, OR 97477 PHONE: (541) 746-0637 E-MAIL: rond@branchengineering.com

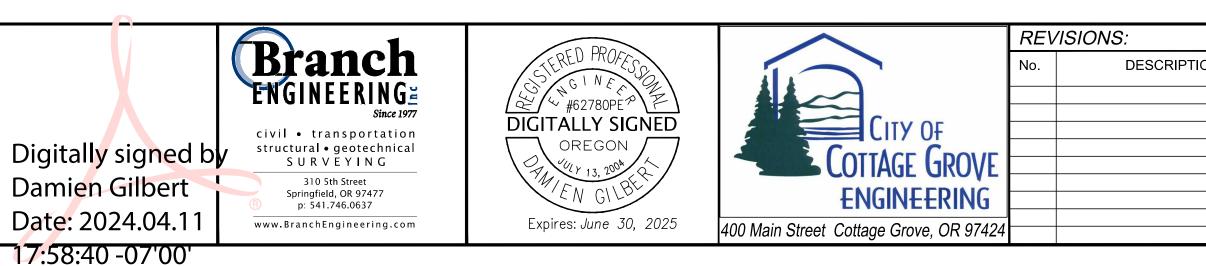

ALL FILL WILL COME FROM APPROVED LOCAL SOURCES.

# SHEET INDEX

EC000 EROSION CONTROL NOTES EC100 EROSION CONTROL PLAN EC200 EROSION CONTROL DETAILS

# ENGINEER/ESCP PREPARER

BRANCH ENGINEERING, INC. CONTACT: DAMIEN GILBERT, P.E. 310 5TH STREET SPRINGFIELD, OR 97477 PHONE: (541) 746-0637 E-MAIL: damieng@branchengineering.com


# SURVEYOR

BRANCH ENGINEERING, INC. CONTACT: DANIEL NELSON, PLS 310 5TH STREET SPRINGFIELD, OR 97477 PHONE: (541) 746-0637 E-MAIL: dann@branchengineering.com

# LANDSCAPE ARCHITECT

DOUGHERTY LANDSCAPE ARCHITECTS 474 WILLAMETTE STREET, SUITE 305 EUGENE, OR 97401 PHONE: (541) 683-5803

DN	DATE	<u> </u>	ROVE NSION			
		ESC COVER			Sheet No. ECO	00
		DRAWN BY:	CHECKED BY:	DATE:		
		ZZ	DG	04/10/24	JOB No.	22-001K

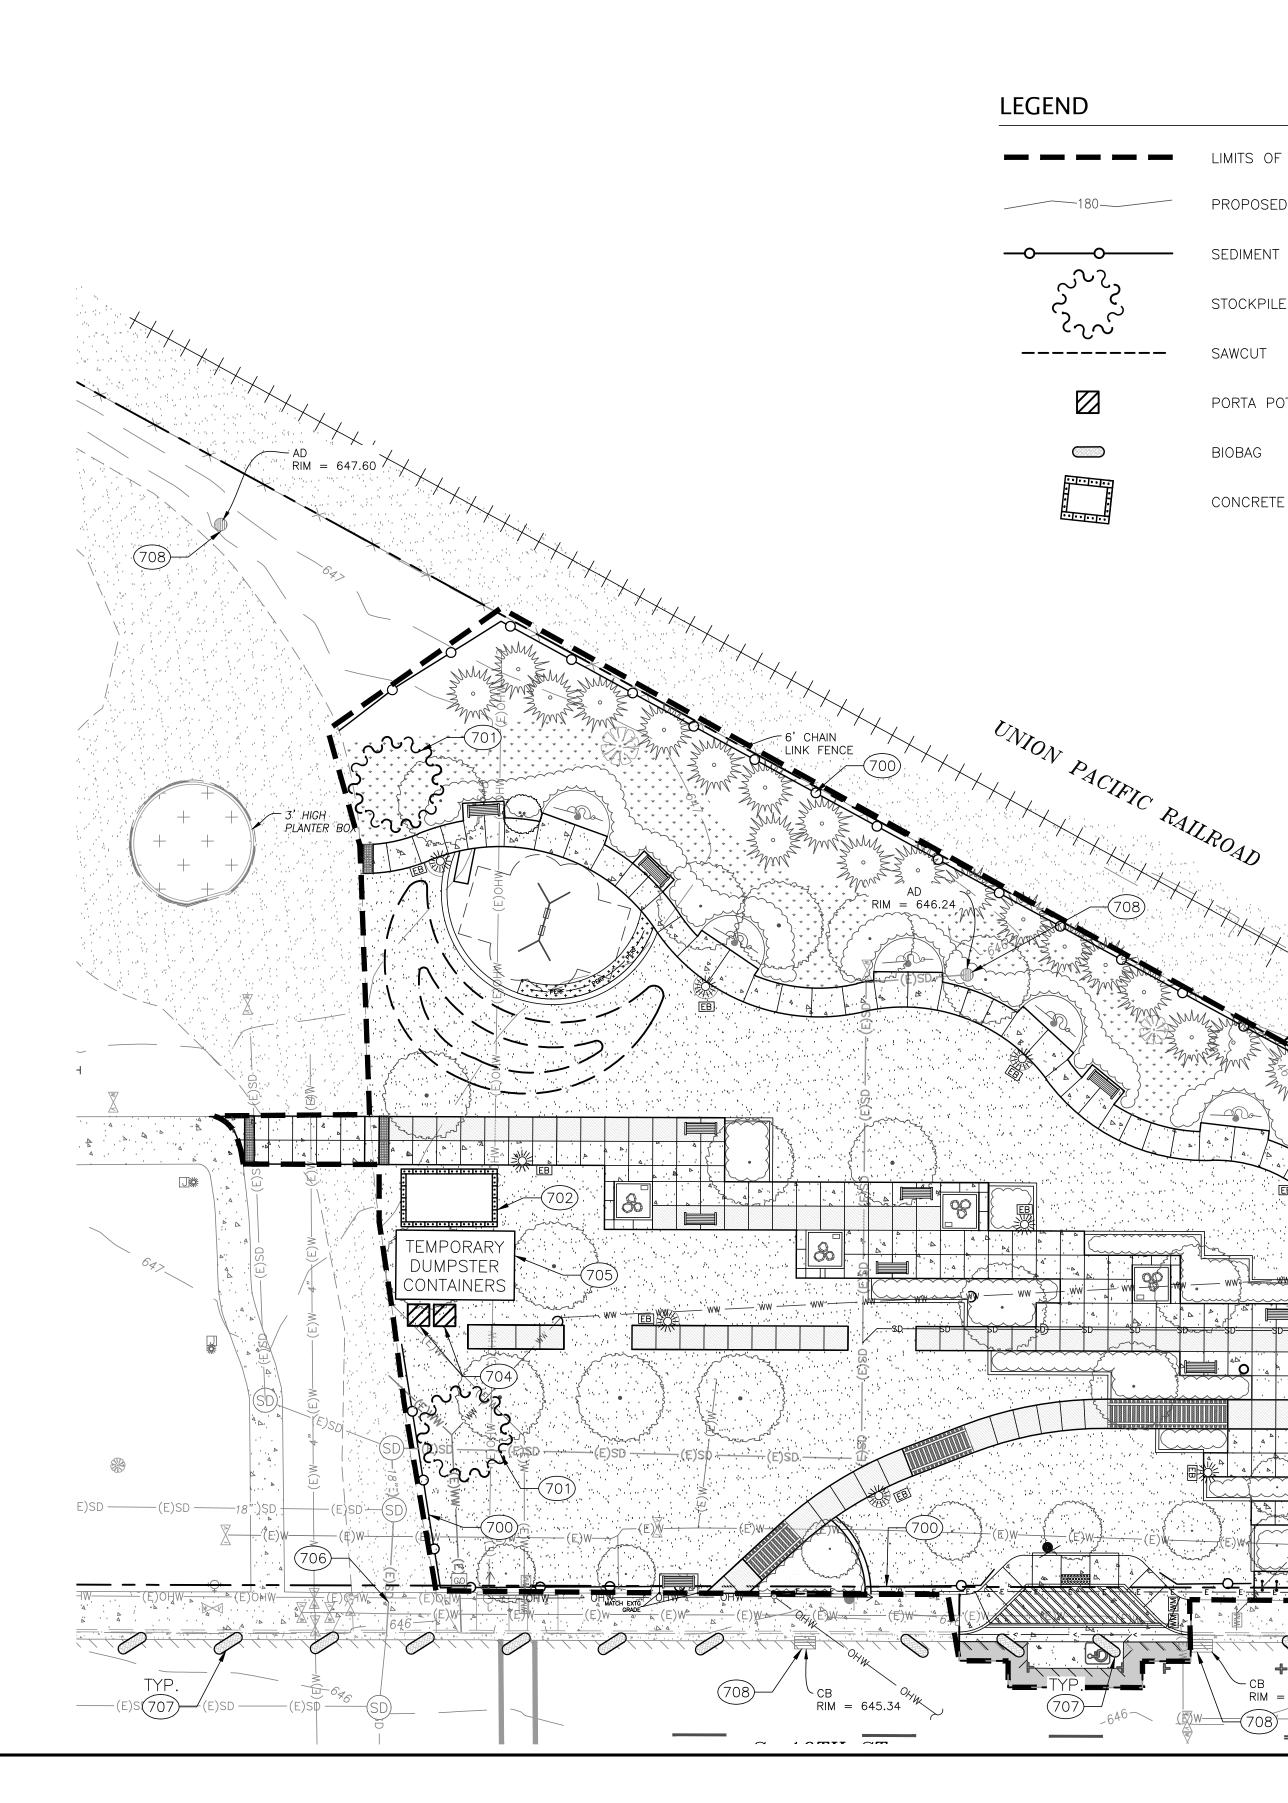

	LIMITS OF DISTURBANCE
	PROPOSED CONTOUR
	SEDIMENT FENCE, OR APPROVED ALTERNATE.
	STOCKPILE
_	SAWCUT
	PORTA POTTY
	BIOBAG

CHAIN LINK

80

RIM = 645.62

CONCRETE WASHOUT

# CONSTRUCTION NOTES

- STANDARD DETAIL NO. 701, SHEET EC200.
- PRIOR TO INSTALLATION.

- (704) PROVIDE AND MAINTAIN PORTABLE TOILETS PER OSHA STANDARDS.
- (705) PROVIDE PROPER DUMPSTER CONTAINERS FOR CONSTRUCTION DEBRIS.
- (706) EXISTING CONSTRUCTION ENTRANCE.
- (707) INSTALL BIO-FILTER BAGS.

# EROSION CONTROL NOTES

- APPLICABLE STATE, FEDERAL AND LOCAL REGULATIONS.
- INSTALLED BEFORE BEGINNING CONSTRUCTION.


# RESTORATION NOTES


- CONDITIONS.
- REPLACED AT CONTRACTOR'S EXPENSE.

# UTILITY NOTES

ATTENTION: OREGON LAW REQUIRES YOU TO FOLLOW RULES ADOPTED BY THE OREGON UTILITY NOTIFICATION CENTER. THOSE RULES ARE SET FORTH IN OAR 952-001-0001 THROUGH 952-001-0090. YOU MAY OBTAIN COPIES OF THE RULES BY CALLING THE CENTER AT (503) 232–1987 OR VISITING THEIR WEBS SITE AT WWW.DIGSAFELYOREGON.COM

CALL THE TOLL FREE "ONE-CALL" NUMBER AT 800-332-2344 OR 811 FOR LOCATES AT LEAST TWO DAYS IN ADVANCE OF EXCAVATION.

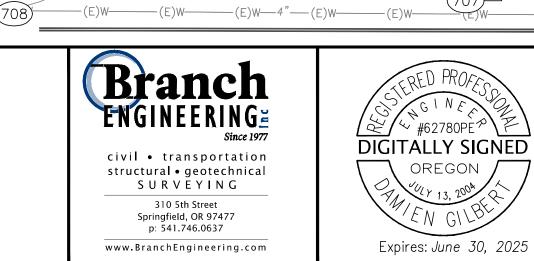

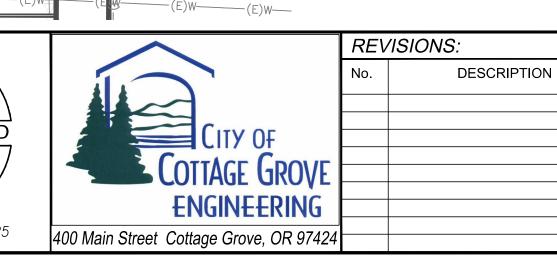

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(70) CONSTRUCT SEDIMENT FENCE, BARK BERM OR APPROVED FILTER MEDIA PER CITY OF COTTAGE GROVE

(701) APPROXIMATE TEMPORARY STOCK PILE LOCATION. INSTALL PLASTIC SHEETING ON STOCK PILE PER ODOT STANDARD DETAIL DET6001, SHEET EC200. CONTRACTOR SHALL COORDINATE LOCATION WITH INSPECTOR

(702) CONSTRUCT CONCRETE WASHOUT AREA PER ODOT STANDARD DETAIL RD1070, SHEET EC200.

703 SAWCUT AS NEEDED AND REMOVE EXISTING CONCRETE COLLAR, GRATE AND TREE. ENSURE THAT NO CONTAMINANTS RESULTING FROM SAWCUTTING ACTIVITIES ENTER THE STORMWATER SYSTEM.


(708) INSTALL TYPE 4 INLET PROTECTION PER ODOT STANDARD DRAWING RD1015 ON SHEET EC200.

A. USE PROTECTIVE MEASURES TO PREVENT DEBRIS FROM ENTERING ADJACENT PROPERTIES AND RIGHT OF WAY. B. ALL WASTE MATERIAL ASSOCIATED WITH THIS PROJECT SHALL BE PICKED UP AND DISPOSED OF ACCORDING TO C. CONTRACTOR SHALL SEED AND MULCH (UNIFORMLY BY HAND OR HYDROSEED) EXPOSED SLOPES AND DISTURBED AREAS WHICH ARE NOT SCHEDULED TO BE LANDSCAPED. INCLUDING TRENCH RESTORATION AREAS. IF THE CONTRACTOR FAILS TO APPLY SEED AND MULCH IN A TIMELY MANNER DURING PERIODS FAVORABLE FOR GERMINATION, OR IF THE SEEDED AREAS FAIL TO GERMINATE, THE OWNER REPRESENTATIVE MAY (AT HIS


DISCRETION) REQUIRE THE CONTRACTOR TO INSTALL SOD TO COVER SUCH DISTURBED AREAS. D. ALL EXISTING AREA DRAINS, TRENCH DRAINS AND CATCH BASINS SHALL HAVE OLD CASTLE FLO-GARD INSERTS

A. RESTORE OR REPLACE ANY DISTURBED LANDSCAPING OF ADJACENT PROPERTIES TO NEW OR BETTER


B. DAMAGE TO PROPERTY BOTH PUBLIC AND PRIVATE DUE TO CONSTRUCTION ACTIVITIES SHALL BE REPAIRED OR

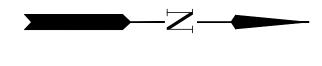



GRAPHIC SCALE

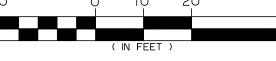


ΓΙΟΝ	DATE	CITY OF COTTAGE GROVE BOHEMIA PARK EXPANSION					
		ESC PLAN			Sheet No. EC100		
		DRAWN BY:	CHECKED BY:	DATE:	1		
		ZZ	DG	04/10/24	JOB No.	22-001K	

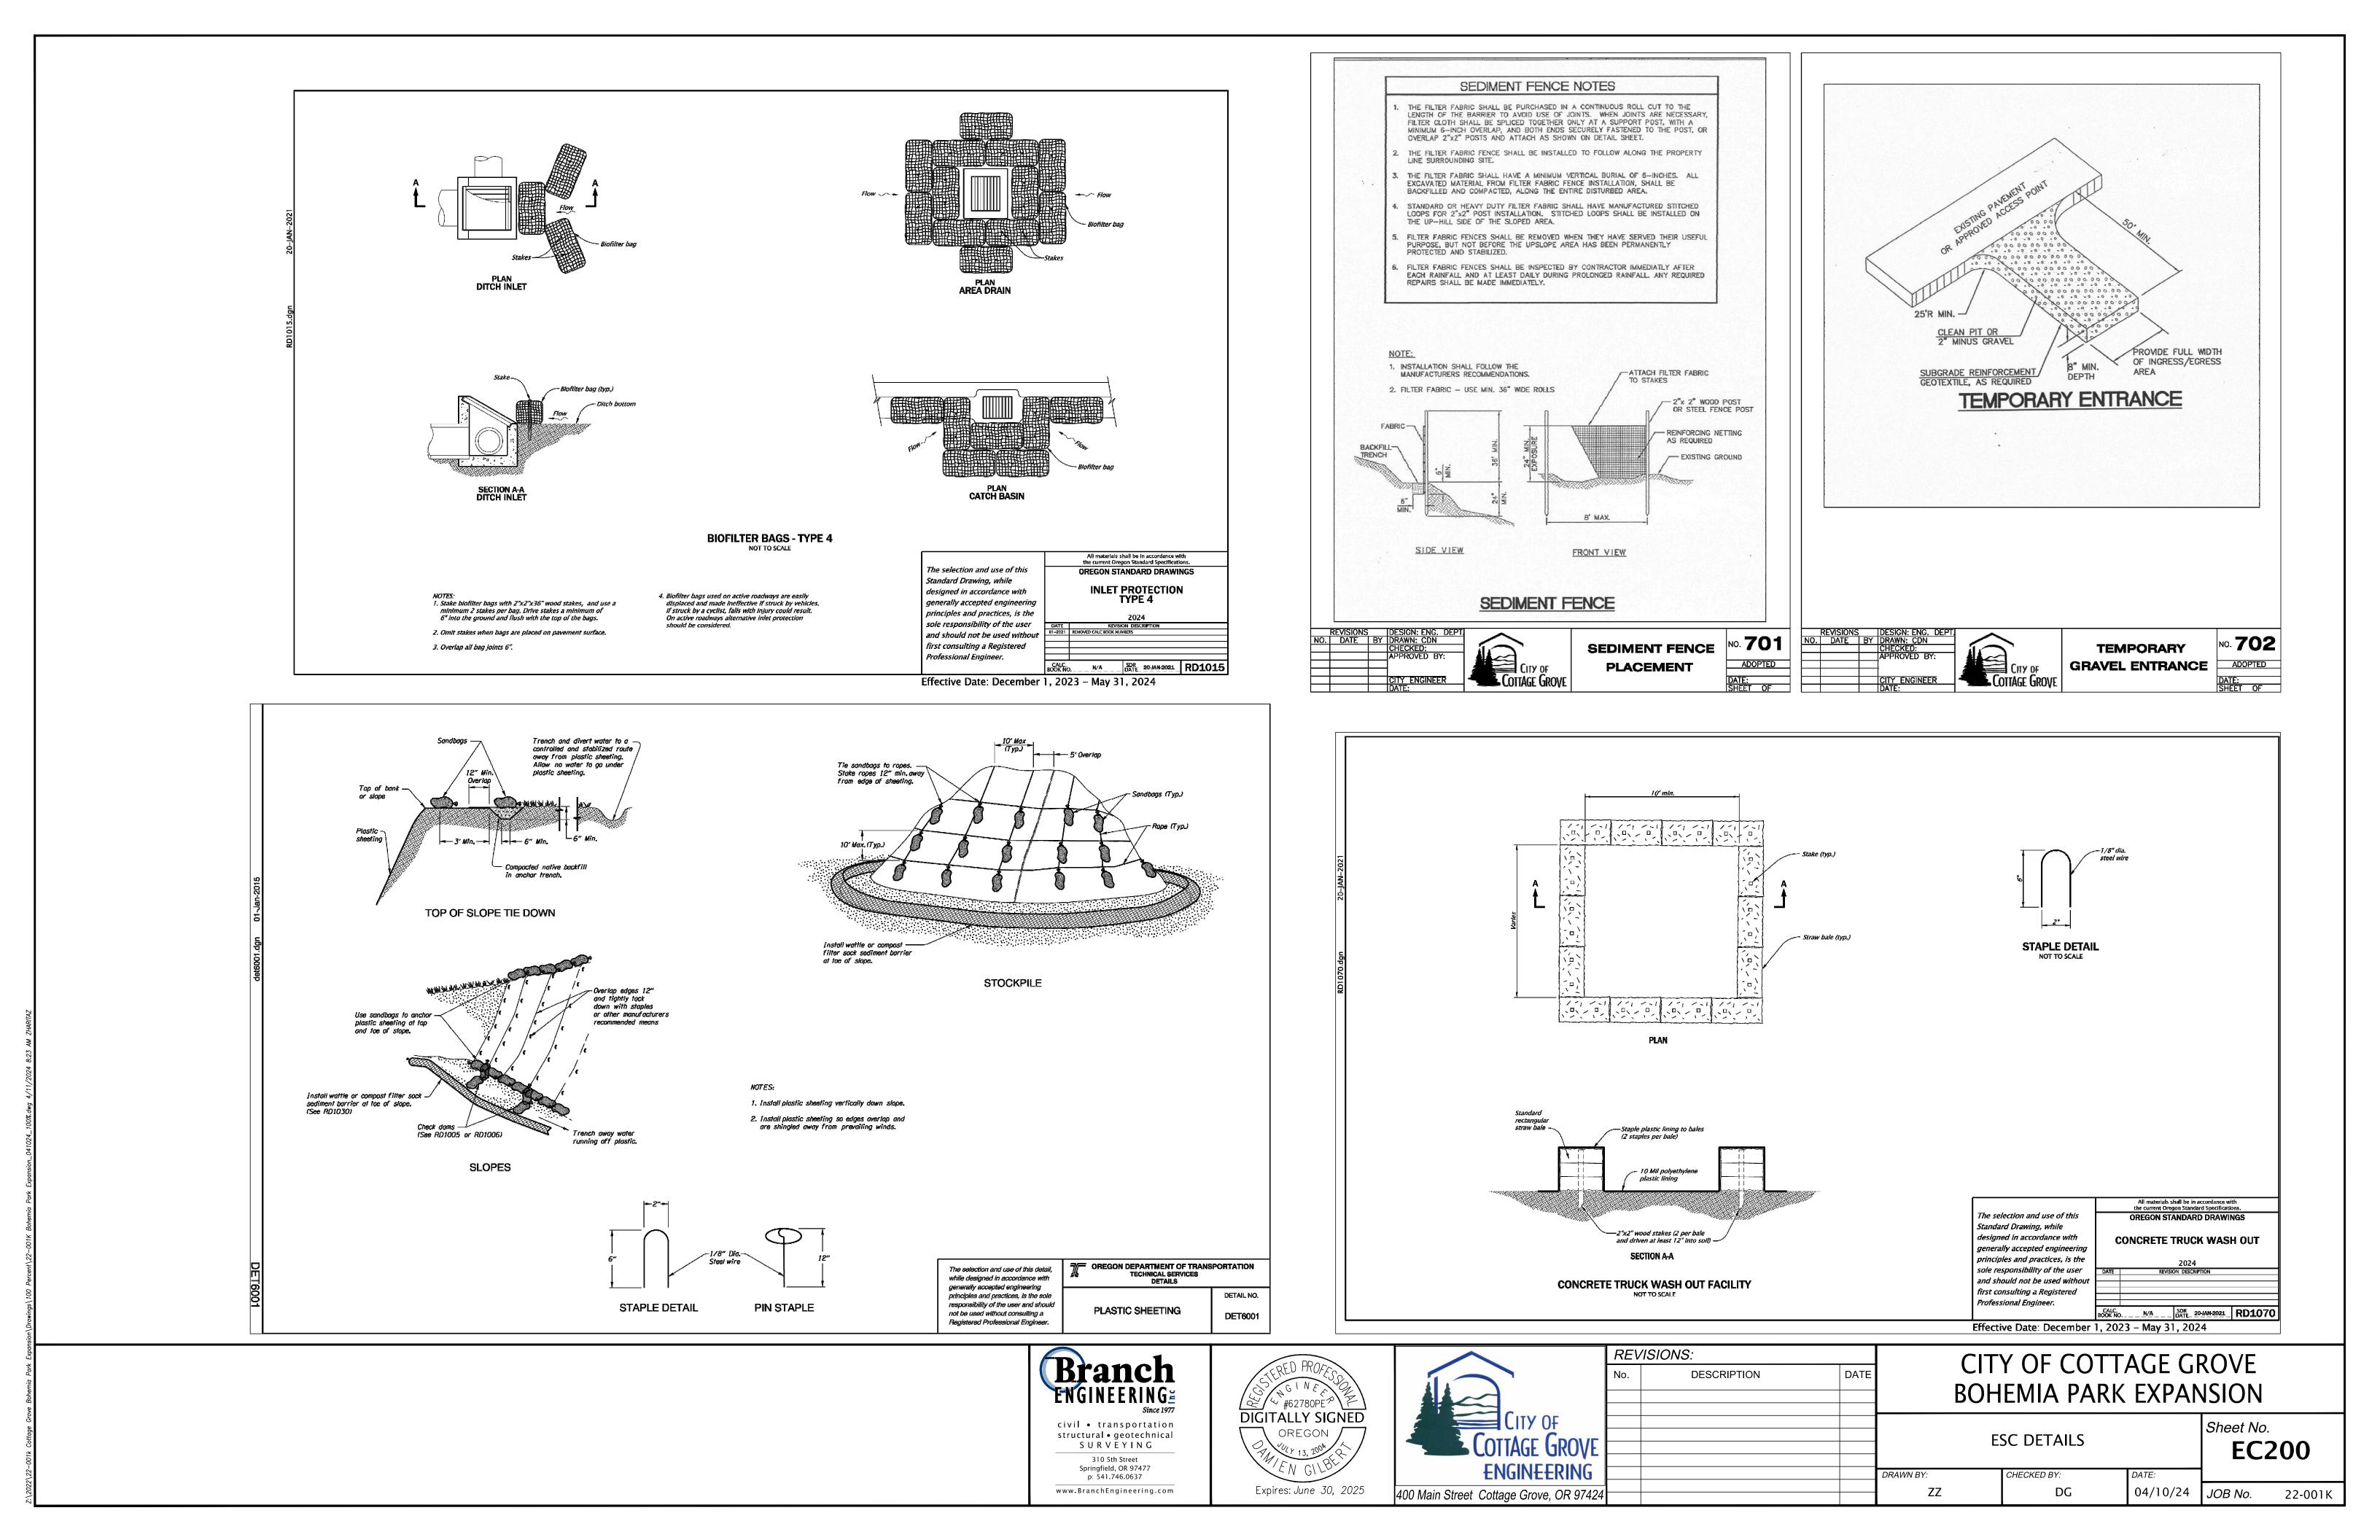

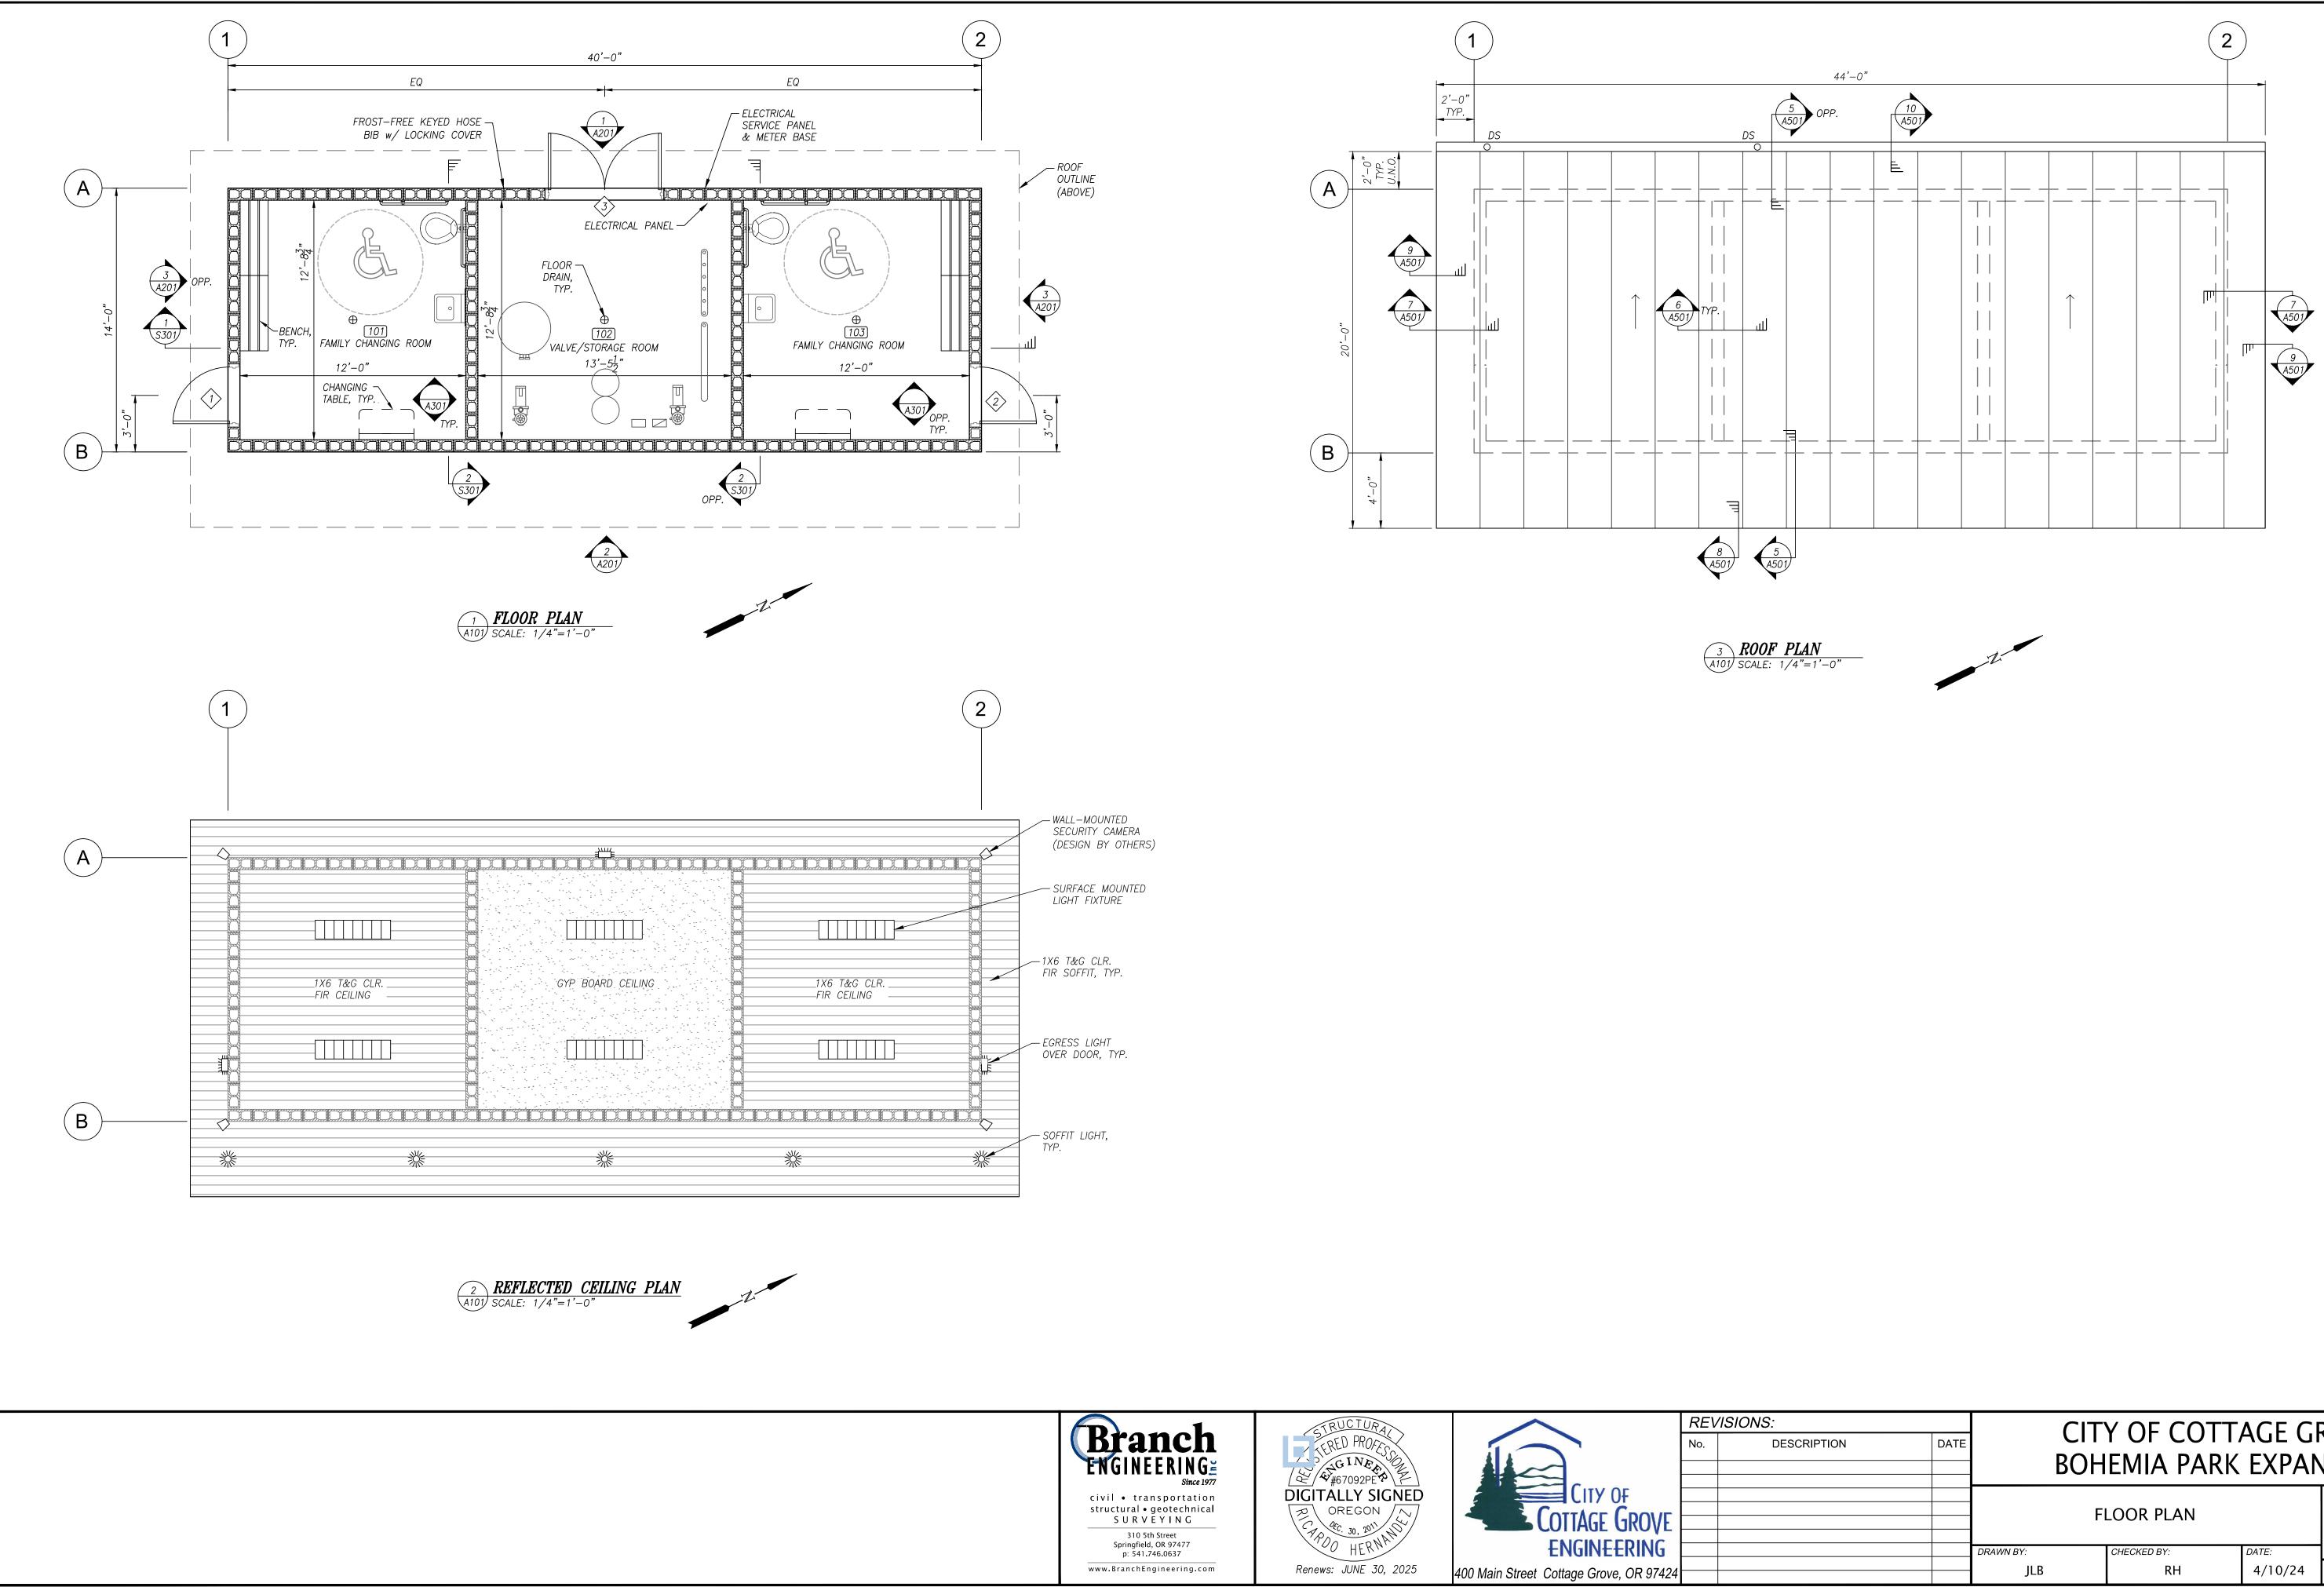


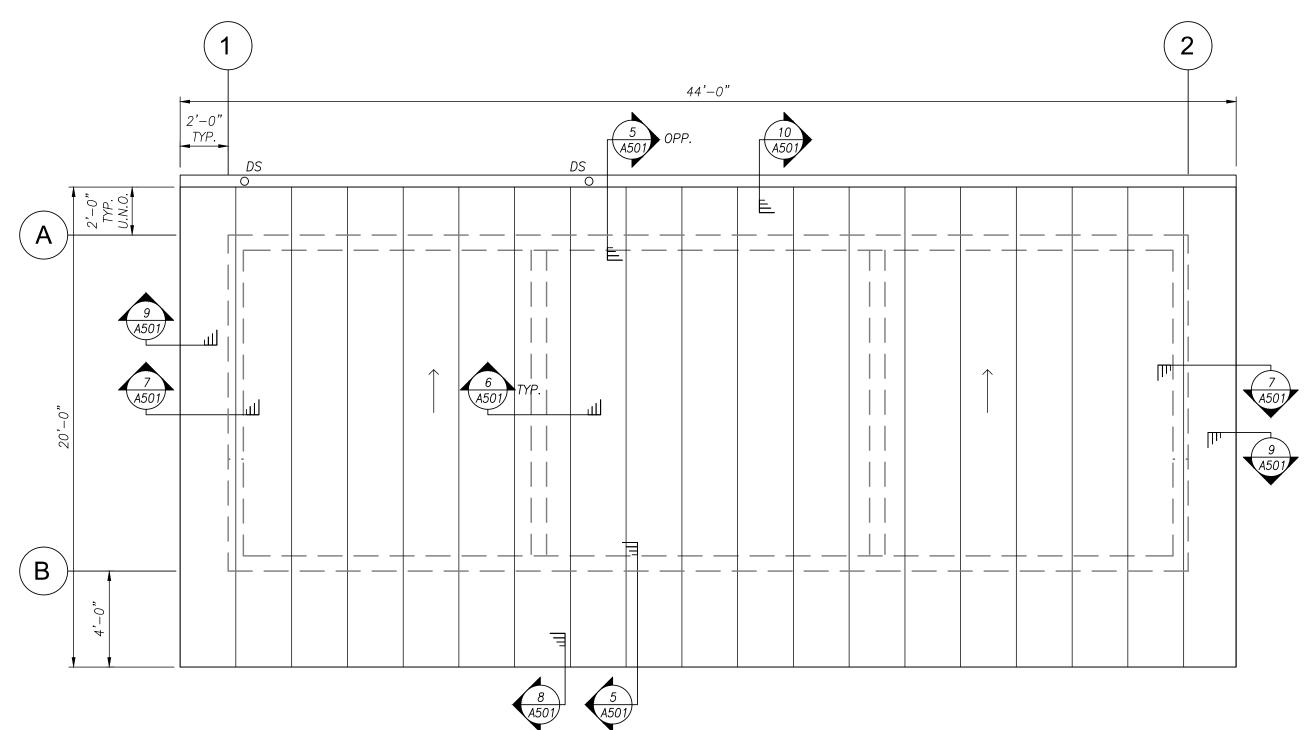

ION	DATE	<b>—</b> — — —		TAGE GROVE K EXPANSION			
		FLOOR PLAN			Sheet No.		
		DRAWN BY:	CHECKED BY:	DATE:			
		JLB	RH	4/10/24	JOB No.	22-001K	

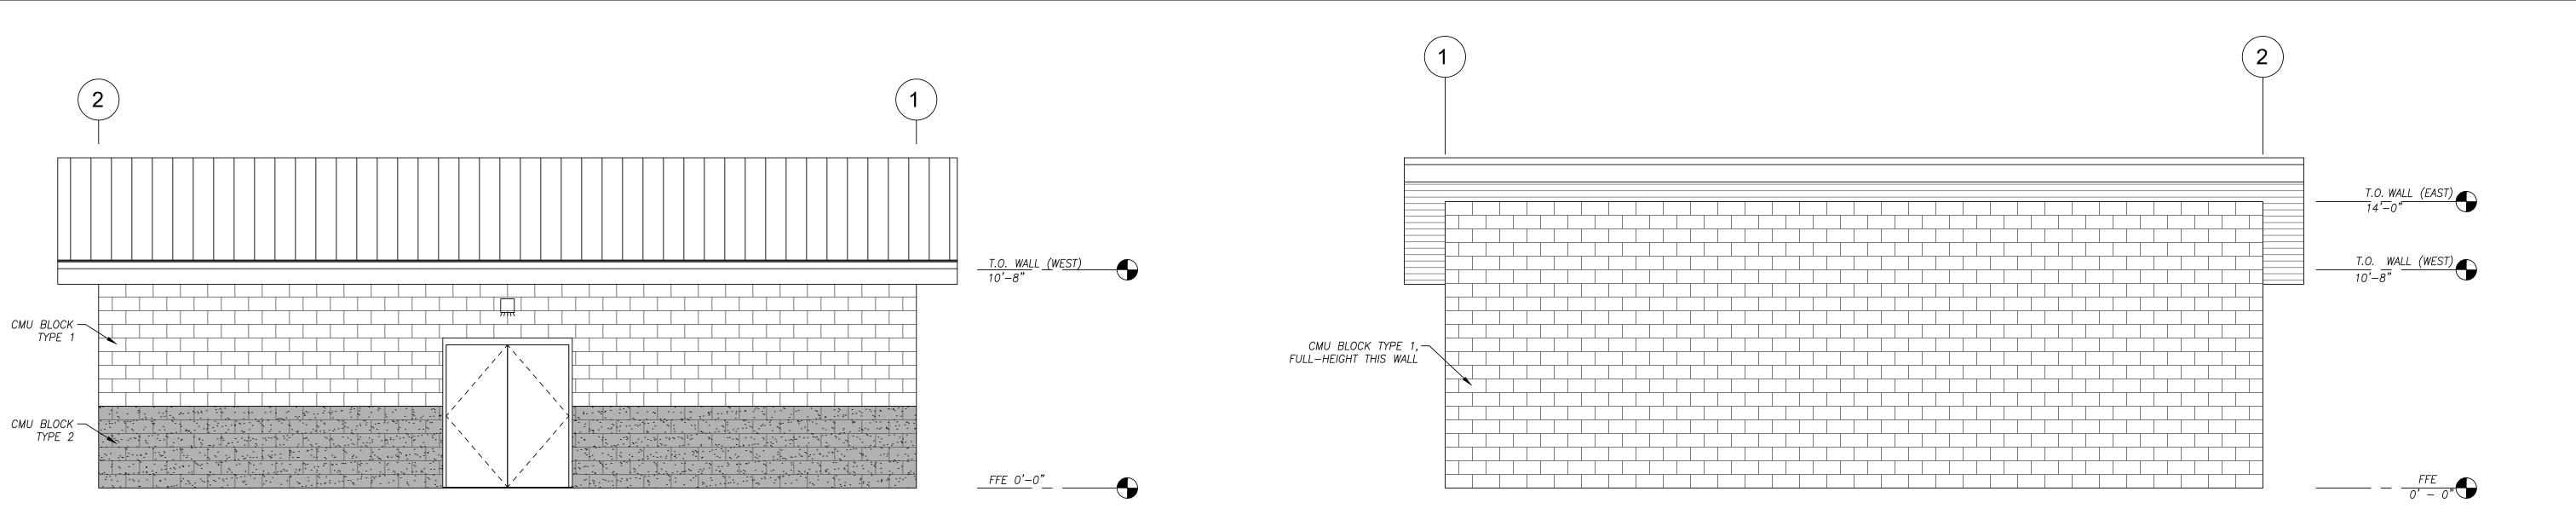

1 **WEST ELEVATION** A201 SCALE: 1/4"=1'-0"

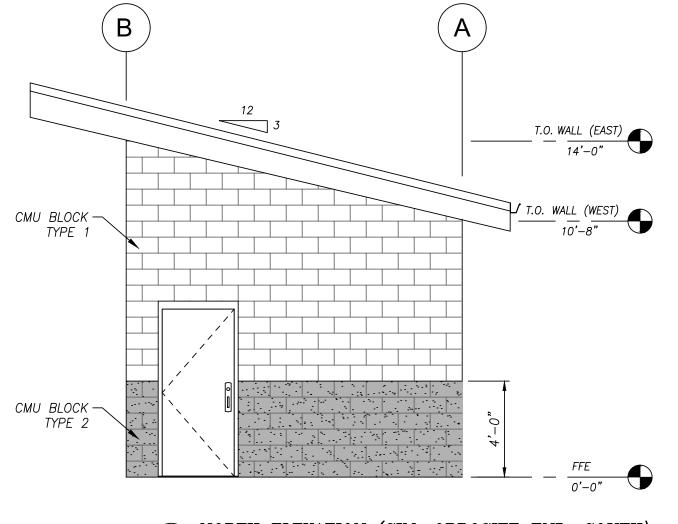


3 NORTH ELEVATION (SIM. OPPOSITE END, SOUTH) A201) SCALE: 1/4"=1'-0"

2 A201 SCALE: 1/4"=1'-0"




ION	DATE		CITY OF COTTAGE GROVE BOHEMIA PARK EXPANSION				
		FLOOR PLAN			Sheet No. <b>A2</b>	01	
		DRAWN BY:	CHECKED BY:	DATE:			
		JLB	RH	4/10/24	JOB No.	22-001K	

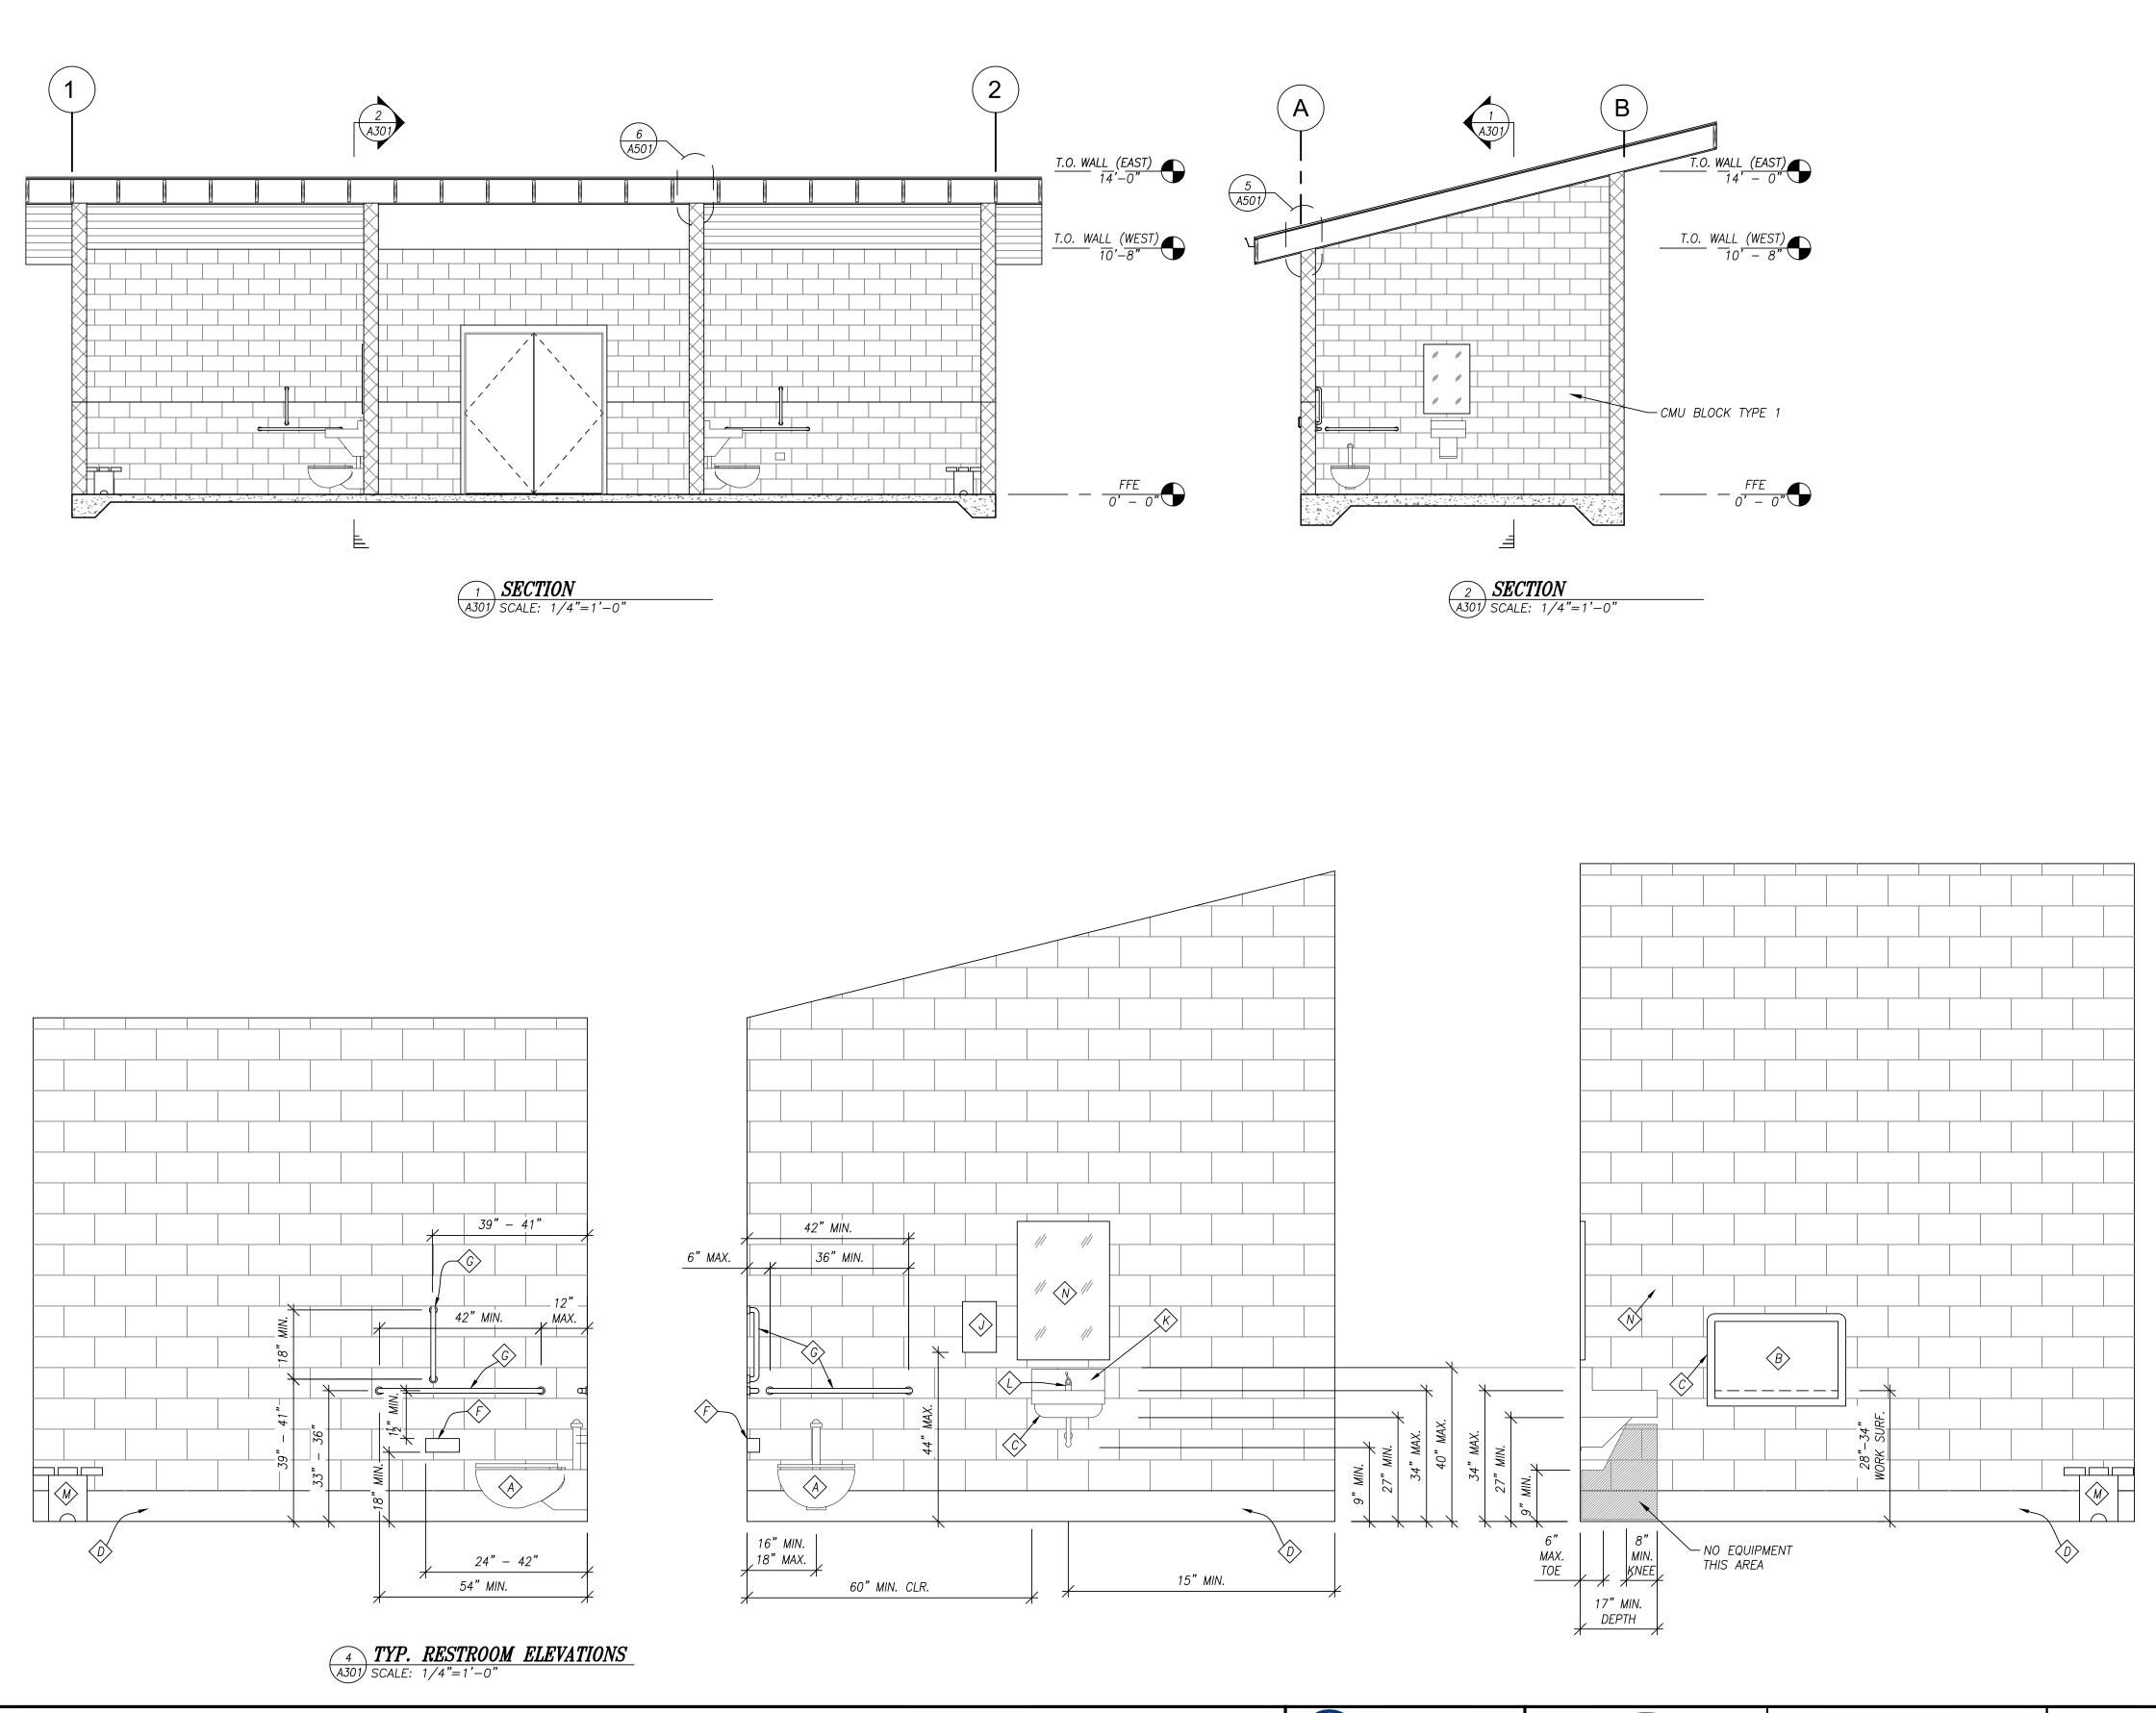



### RESTROOM NOTES

- ACCESSIBLE WALL HUNG WATER CLOSET
- B STANDARD BABY CHANGING TABLE
- $\stackrel{\circ}{\bigcirc}$  WALL-MOUNT LAVATORY. R-3 INSULATION (TRAP COVERS) ON EXPOSED PIPING.
- D EXTEND RESINOUS FLOOR SURFACING 8" UP WALL, TYP. ALL WALLS
- $\langle F \rangle$  ADA COMPLIANT TOILET PAPER DISPENSER FOR 9" ROLL 2 DISPENSERS PER STALL.
- $\langle \widehat{G} \rangle$  ADA COMPLIANT GRAB BAR.
- $\langle H \rangle$  accessible door handle see hardware schedule.
- (I) ACCESSIBLE MEN / WOMEN / FAMILY RESTROOM SIGN.
- $\langle J \rangle$  ADA COMPLIANT AIR HAND DRYER.
- $\langle K \rangle$  ADA COMPLIANT SOAP DISPENSER INTEGRAL w/ LAVATORY
- $\langle L \rangle$  ADA COMPLIANT LAVATORY FAUCET.
- (M) ACCESSIBLE BENCH
- $\stackrel{\scriptstyle }{\swarrow}$  24"x36" MIRROR w/ STAINLESS STEEL FRAME & ACRYLIC GLASS COVER PANE.

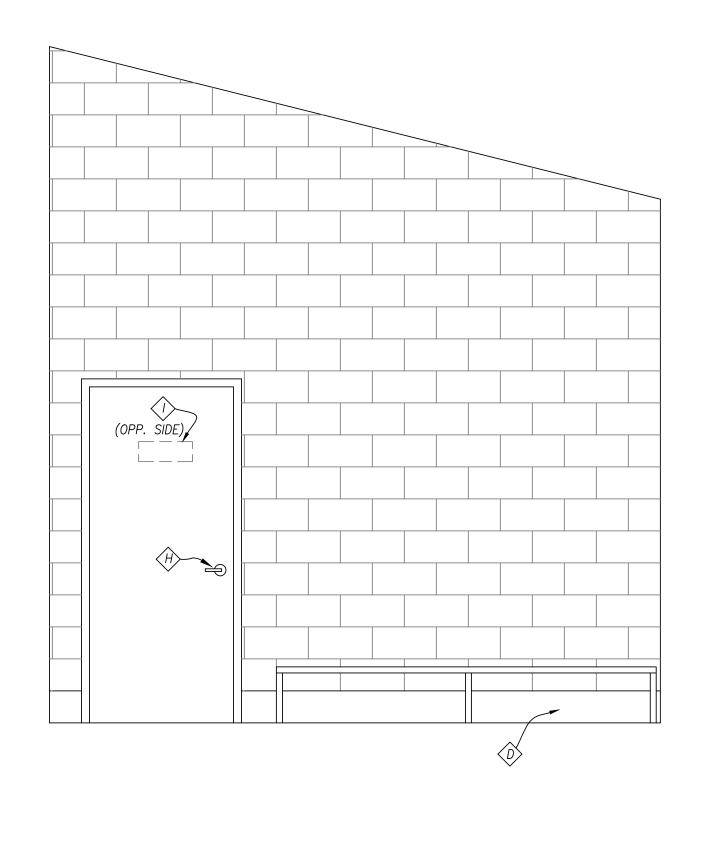

DATE	CITY OF COTTAGE GROVE BOHEMIA PARK EXPANSION				
	SECTIONS &	S Sheet No.			
	DRAWN BY:	CHECKED BY:	DATE:		
	JLB	RH	4/10/24	JOB No.	22-001K
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